

THE CITY OF ROSWELL

LAND LOT 410 1st DISTRICT, 2nd SECTION, FULTON COUNTY, GEORGIA

1760-ZONING.DWG

603 Macy Drive Roswell, GA 30076

TREE ORDINANCE NOTES:

1. CRITICAL ROOT ZONE (CRZ): THE MINIMUM AREA BENEATH A TREE WHICH MUST BE LEFT UNDISTURBED IN ORDER TO PRESERVE A SUFFICIENT ROOT MASS TO GIVE A TREE A REASONABLE CHANCE OF SURVIVAL. THE CRZ WILL TYPICALLY BE REPRESENTED BY A CONCENTRIC CIRCLE CENTERING ON THE TREE'S TRUNK WITH A RADIUS EQUAL IN FEET TO ONE AND ONE-HALF (1.5) TIMES THE NUMBER OF INCHES OF THE TRUNK DIAMETER. EXAMPLE: THE CRZ RADIUS OF A TWENTY-INCH DIAMETER TREE IS THIRTY (30) FEET.

- 2. SPECIMEN TREE: ANY TREE, AS DEFINED BY THIS ARTICLE, IN FAIR OR BETTER CONDITION, WHICH QUALIFIES FOR SPECIAL CONSIDERATION FOR PRESERVATION DUE TO SIZE, SPECIES, OR CONDITION, AND WHICH MEETS THE FOLLOWING:
 - 24" DBH LARGE HARDWOODS SUCH AS OAKS, HICKORIES, YELLOW POPLARS, SWEETGUMS, ETC. 30" DBH - LARGE SOFTWOODS SUCH AS PINES, DEODAR CEDARS, ETC. 4" DBH - SMALL TREES SUCH AS DOGWOODS, REDBUDS, SOURWOODS, ETC.
- 3. THE TREE SURVEY SHALL BE IN THE FORM OF A TO-SCALE MAP OR A SITE PLAN PREPARED AND SEALED BY A REGISTERED LAND SURVEYOR, REGISTERED PROFESSIONAL ENGINEER, REGISTERED LANDSCAPE ARCHITECT, AN ARBORIST CERTIFIED BY THE INTERNATIONAL SOCIETY OF ARBORICULTURE, OR A REGISTERED FORESTER NOTING THE LOCATION OF ALL SPECIMEN TREES PLUS ALL OTHER TREES WHICH WILL BE PRESERVED AND COUNTED TOWARD MEETING SITE TREE DENSITY UNIT REQUIREMENTS ESTABLISHED IN THIS ARTICLE. IMPORTANT NATURAL FEATURES SUCH AS STREAMS AND WETLANDS SHALL ALSO BE SHOWN ON THE TREE SURVEY.
- 4. ALL SPECIMEN TREES AND THEIR CRITICAL ROOT ZONES AND DRIP LINES SHALL BE LABELED, EVEN IF THE TREE TRUNK IS NOT ON THE SUBJECT PROPERTY, AND MUST BE SHOWN ON THE TREE SURVEY AND INVENTORIED BY SIZE AND SPECIES. THIS INCLUDES THOSE SPECIMEN TREES THAT ARE TO BE PRESERVED AS WELL AS THOSE PROPOSED FOR REMOVAL, IF ANY, AND THE PORTION OF CRITICAL ROOT ZONES AND DRIP LINES OF TREES ON ABUTTING PROPERTIES WHICH ARE CONTAINED WITHIN THE SUBJECT PROPERTY, TO THE EXTENT THAT SUCH DRIP LINES AND CRITICAL ROOT ZONES CAN BE DETERMINED FROM THE VANTAGE POINT OF THE PROPERTY TO BE DEVELOPED. THIS PROVISION SHALL NOT AUTHORIZE THE TRESPASS ON OTHER PRIVATE PROPERTY ABUTTING THE SITE.
- 5. TREES OTHER THAN SPECIMEN TREES THAT ARE PROPOSED TO BE REMOVED AND WHICH THUS CANNOT BE COUNTED TOWARD TREE DENSITY UNIT REQUIREMENTS, ARE NOT REQUIRED TO BE COUNTED AND SHOWN INDIVIDUALLY ON THE TREE SURVEY. SUCH TREES SHALL BE ESTIMATED IN NUMBER, SIZE AND SPECIES OF SUCH TREES AND QUANTIFIED AS PART OF THE TOTAL SITE INVENTORY OF TREE POPULATION.
- 6. SAMPLING, SAMPLING METHODS MAY BE USED TO DETERMINE TREE DENSITIES FOR FORESTED AREAS OVER TWO (2) ACRES.
- 7. ALL TREE SAVE AREAS MUST BE DELINEATED ON THE TREE SURVEY. ALL BUFFERS WITH EXISTING TREES MUST BE DELINEATED ON THE TREE SURVEY AS TREE SAVE AREAS. LAND DISTURBANCE WITHIN ANY BUFFER IS SUBJECT TO APPROVAL BY THE ARBORIST.
- 8. NO STRUCTURE(S), IMPROVEMENT(S), OR ANY ACTIVITY INCLUDING SOLVENTS, MATERIAL, CONSTRUCTION MACHINERY, PORTABLE TOILETS, CONSTRUCTION TRAILERS, OR TEMPORARY SOIL DEPOSITS SHALL ENCROACH OR BE PLACED WITHIN A DRIP LINE AND WITHIN SIX (6) FEET OF THE AREA IMMEDIATELY OUTSIDE THE DRIP LINE, OF ANY SPECIMEN TREE OR ANY TREE WITHIN A TREE SAVE AREA UNLESS AUTHORIZED BY THE
- 9. BEFORE DEVELOPMENT, LAND CLEARING, FILLING, OR ANY LAND ALTERATION, THE DEVELOPER SHALL BE REQUIRED TO ERECT SUITABLE PROTECTIVE BARRIERS AS REQUIRED BY THE ARBORIST PURSUANT TO AN APPROVED TREE PROTECTION PLAN, INCLUDING TREE FENCES, TREE PROTECTION SIGNS, AND EROSION BARRIERS. INSPECTION OF TREE PROTECTION BARRIERS IS REQUIRED PRIOR TO THE COMMENCEMENT OF ANY LAND DISTURBANCE OR DEVELOPMENT, SAID TREE PROTECTION MEASURES SHALL REMAIN IN FUNCTIONING CONDITION UNTIL COMPLETION OF SITE LANDSCAPING, COMPLETION OF THE PROJECT, OR UNTIL THE CERTIFICATE OF OCCUPANCY IS ISSUED. AUTHORIZATION TO REMOVE THE PROTECTIVE DEVICES SHALL BE EVIDENCED IN WRITING BY THE ARBORIST OR BY THE ISSUANCE OF A FINAL CERTIFICATE OF OCCUPANCY.
- 10. MATERIALS FOR ACTIVE TREE PROTECTION SHALL CONSIST OF CHAIN LINK, ORANGE LAMINATED PLASTIC, WOODEN POST AND RAIL FENCING OR OTHER EQUIVALENT RESTRAINING MATERIAL. IN ADDITION TO FENCING, WHERE ACTIVE TREE PROTECTION IS REQUIRED, EACH TREE TO BE SAVED SHALL BE MARKED AT THE BASE OF THE TRUNK WITH BLUE COLORED WATER-BASED PAINT.
- 11. SPECIMEN RECOMPENSE CONTRIBUTIONS TO THE ROSWELL TREE BANK MAY BE ADJUSTED BY RECOMPENSE SUBJECT TO THE FOLLOWING

CREDIT, BASED ON THE TREE DENSITY UNITS AS SPECIFIED IN TABLE 15.7.2, MAY BE GIVEN FOR NEW TREES PLANTED ON THE SUBJECT SITE, ABOVE AND BEYOND THE MINIMUM SITE DENSITY REQUIREMENT, IF APPROVED BY THE CITY ARBORIST.

SUCH NEWLY PLANTED TREES SHALL BE OF A CALIPER OF FOUR (4) INCHES OR GREATER.

- IN CASES WHERE THE OBLIGATION IS NOT FULLY REDUCED BY RECOMPENSED TREES, THE REMAINING OBLIGATION SHALL BE DEPOSITED TO THE ROSWELL TREE BANK AND CALCULATED BASED ON \$500.00 PER DENSITY UNIT.
- 12. A BASIC REQUIREMENT OF THIS ARTICLE IS THAT ALL APPLICABLE SITES, INCLUDING ALL SINGLE FAMILY AND/OR DUPLEX RESIDENTIAL LOTS ONE (1) ACRE OR GREATER IN SIZE, SHALL MAINTAIN A MINIMUM TREE DENSITY OF THIRTY (30) UNITS PER ACRE. THE TERM "UNIT" IS AN EXPRESSION OF BASAL AREA, AND IS NOT SYNONYMOUS WITH "TREE". THE DENSITY REQUIREMENT MUST BE MET WHETHER OR NOT A SITE HAD TREES PRIOR TO DEVELOPMENT FOR THE ISSUANCE OF A DEVELOPMENT PERMIT.
- 13. THE FOLLOWING STANDARDS HAVE BEEN ESTABLISHED FOR ADMINISTERING THIS ALTERNATIVE COMPLIANCE METHOD. THE ARBORIST MUST REVIEW AND APPROVE ALL REQUESTS FOR ALTERNATIVE COMPLIANCE. IN NO INSTANCE SHALL MORE THAN NINETY (90) PERCENT OF THE REQUIRED SITE DENSITY BE MET THROUGH ALTERNATIVE COMPLIANCE. AS MANY TREES AS CAN REASONABLY BE EXPECTED TO SURVIVE MUST BE PLANTED ON THE SITE IN QUESTION. THIS PROVISION MAY REQUIRE PLANTING LESS TREES OF A LARGER CALIPER THAN THE MINIMUM REQUIRED
- 14. REPLACEMENT TREE SIZE AND HEIGHT. ALL REPLANTED OVERSTORY TREES SHALL BE A MINIMUM OF EIGHT (8) FEET TALL AND HAVE A TRUNK OF NOT LESS THAN THREE-CALIPER INCHES. ALL REPLACED UNDERSTORY TREES SHALL BE A MINIMUM OF SIX (6) FEET TALL AND HAVE A TRUNK OF NOT LESS THAN TWO (2) INCHES. IN ORDER TO PROVIDE SUFFICIENT GROWING AREA FOR PLANTED TREES, THE FOLLOWING MINIMUM CRITERIA MUST BE OBSERVED UNLESS OTHERWISE APPROVED BY THE ARBORIST:

OVERSTORY TREES - TWO HUNDRED (200) SQUARE FEET OF PERVIOUS ROOT ZONE UNDERSTORY TREES - SEVENTY-FIVE (75) SQUARE FEET OF PERVIOUS ROOT ZONE

IMPERVIOUS SURFACE AREA MAY ENCROACH INTO NO MORE THAN THIRTY (30) PERCENT OF THE PERVIOUS ROOT ZONE OF A TREE TO BE PROTECTED OR PLANTED, WITH TECHNIQUES APPROVED BY THE ARBORIST.

DIVERSITY, NO MORE THAN FORTY (40) PERCENT OF ANY ONE GENUS MAY BE INCLUDED IN ANY REPLANTING PLAN. EXCEPTIONS TO THIS REQUIREMENT MAY BE AUTHORIZED BY THE ARBORIST WHERE IN HIS OR HER OPINION AN EXCEPTION IS JUSTIFIED.

PLANTING AND STAKING DETAILS. PLANTING AND STAKING DETAILS SHALL BE PROVIDED ON THE PLAN AS DETERMINED BY THE ARBORIST USING INTERNATIONAL SOCIETY OF ARBORICULTURE (ISA) STANDARDS.

- 15. STREET TREE PLANTING IS REQUIRED ALONG ALL NEW LOCAL, COLLECTOR, AND ARTERIAL STREETS IN THE CITY OF ROSWELL AND PRIVATE STREETS WITHIN COMMERCIAL, INDUSTRIAL, OR RESIDENTIAL SUBDIVISIONS.
- 16. STREET TREES MUST BE PLANTED WITHIN THE PUBLIC RIGHT-OF-WAY OR, IF RIGHT-OF-WAY WIDTH IS INSUFFICIENT TO ACCOMMODATE SAID STREET TREES, THEN ON PRIVATE PROPERTY ABUTTING THE PUBLIC RIGHT OF WAY WITHIN A STREET TREE EASEMENT DEDICATED TO THE CITY. FOR LOCAL, ARTERIAL, AND COLLECTOR STREETS WITH SPEEDS LESS THAN OR EQUAL TO FORTY-FIVE (45) MILES PER HOUR: ON STREETS WITH CURB AND GUTTER, STREET TREES SHOULD BE A MINIMUM OF 1.5 FEET BEHIND THE CURB AND MAY BE PLACED BETWEEN THE SIDEWALK, IF PRESENT, AND THE BACK OF CURB. ON STREETS WITHOUT CURB AND GUTTER, THE TREES SHOULD BE AT LEAST SEVEN (7) TO TEN (10) FEET FROM THE EDGE OF THE TRAVELED WAY, A BIKE PATH IS NOT CONSIDERED PART OF THE TRAVELED WAY, ADEQUATE SIGHT DISTANCE MUST BE AVAILABLE FROM INTERSECTING STREETS AND DRIVEWAYS, UTILITY INSTALLATIONS MUST BE COORDINATED WITH TREE LOCATIONS. IN MANY CASES, THE UNDERGROUND LOCATIONS HAVE THE POTENTIAL FOR CONFLICT. STREET TREES SHALL HAVE EQUAL BEARING WHEN CONSIDERING UTILITY LOCATION.
- 17. WHEN A PERSON APPLIES FOR A DEVELOPMENT PERMIT, SUCH PERSON SHALL ALSO FILE AN APPLICATION FOR A TREE REMOVAL PERMIT PROVIDING THE FOLLOWING INFORMATION:

A COMPLETE TREE SURVEY, AS SPECIFIED IN CHAPTER 15.2.

A COMPLETE TREE PROTECTION PLAN, AS SPECIFIED IN CHAPTER 15.3.

A COMPLETE TREE REPLACEMENT PLAN AS SPECIFIED IN CHAPTER 15.4.

- 18. ALL TREE PROTECTION MEASURES SHALL BE INSTALLED PRIOR TO ANY LAND DISTURBANCE, AND THE ARBORIST SHALL BE CONTACTED FOR A PRE-CONSTRUCTION CONFERENCE PRIOR TO LAND DISTURBANCE. AS A CONDITION OF THE ISSUANCE OF A PERMIT, THE APPLICANT SHALL AGREE IN WRITING TO ENTRY ONTO HIS PREMISES BY REPRESENTATIVES OF THE CITY AS DESIGNATED BY THE ARBORIST TO INSPECT THE PERMIT AND ACTIVITIES AT ANY TIME, AND SUCH ENTRY SHALL BE LAWFUL. FAILURE TO ALLOW SUCH ENTRY SHALL BE UNLAWFUL AND SHALL CONSTITUTE FAILURE TO DISPLAY THE PERMIT AS REQUIRED UNDER THIS SECTION. LAND DISTURBANCE MAY PROCEED ONLY AFTER A TREE REMOVAL PERMIT AND DEVELOPMENT PERMIT ARE OBTAINED. THE ARBORIST SHALL MAKE UNSCHEDULED INSPECTIONS BEFORE AND DURING DEVELOPMENT TO ENSURE PROTECTION OF TREES, CRITICAL ROOT ZONES DRIP LINES, AND BUFFER ZONES. AFTER COMPLETION OF A DEVELOPMENT, BUT PRIOR TO THE ISSUANCE OF A CERTIFICATE OF OCCUPANCY, THE ARBORIST WILL CONDUCT AN ON-SITE INSPECTION OF THE SITE TO ENSURE COMPLIANCE WITH THE APPROVED TREE PROTECTION PLAN AND APPROVED TREE REPLACEMENT PLAN. THE ENGINEERING DIVISION OF THE COMMUNITY DEVELOPMENT DEPARTMENT WILL BE CHARGED WITH THE RESPONSIBILITY OF INSPECTING THE SITE TO ENSURE THAT TREES ARE ADEQUATELY PROTECTED DURING ANY GRADING OF THE PROPERTY FOR INFRASTRUCTURE INSTALLATION.
- 19. THE ZONING DIRECTOR OR ARBORIST MAY INSTRUCT THE BUILDING INSPECTOR TO WITHHOLD THE ISSUANCE OF THE REQUIRED CERTIFICATE OF OCCUPANCY, OR PERMITS AND INSPECTIONS, FOR ANY DEVELOPMENT UNTIL THE PROVISIONS OF THIS ARTICLE HAVE BEEN FULLY MET.
- 20. THE REQUIRED CONTRIBUTION AMOUNT IS \$220.00 PER TREE DENSITY UNIT, BASED ON COST OF MATERIALS, LABOR AND GUARANTEE FOR TREES PLANTED IN THE ROSWELL AREA.

PROJECT CALCULATIONS:

DENSITY SUMMARY:

SITE DENSITY FACTOR (SDF):

SDF = SITE AREA (ACRES) X 30 (UNITS) $SDF = 0.917 \times 30 = 27.51$

SDF = 27.51 UNITS

EXISTING DENSITY FACTOR (EDF):

EDF = REMAINING TREES EDF = NO TREES TO REMAIN

EDF = 0.00 UNITS

REPLACEMENT DENSITY FACTOR (RDF)

RDF = 27.51 UNITS - 0.00 UNITS

RDF = 27.51 UNITS

DENSITY FACTOR DEFICIENT (DFD):

DFD = SDF - EDF - ADJUSTED RDFDFD = 27.51 UNITS - 0.00 UNITS - 15.90

DFD = 11.61 UNITS

11.61 X \$220.00 TREE BANK CONTRIBUTION = \$2554.20

SPECIMEN REMOVALS:

SP = 21.00 UNITS (FULFILLED PER SHEET TP-103 AND ALTERNATIVE COMPLIANCE, TREE BANK)

STB = SPECIMEN TREE BANK STB = 90% MAXSTB = .9 * 21.00 UNITS

STB = 18.90 UNITS * \$500.00TREE BANK CONTRIBUTION = \$9,450.00

SPECIMEN TREE RECOMPENSE STR = REMAINING 10% STR = .1 * 21.00 UNITSSTR = 2.10 UNITS|STR| = 2.10 UNITS

RECOMPENSE PLANTINGS:

TOTAL RECOMPENSE PLANTING TRP = ADJUSTED RDF + STRTRP = 15.90 UNITS + 2.10 UNITS|TRP = 18.00 UNITS| (SEE SHEET TP-103 FOR REQUIRED UNIT FULFILLMENT)

TREE BANK CONTRIBUTION:

REMOVED 21.00 SAVED 0

TOTAL TREE BANK CONTRIBUTION TBC = DFD + STBTBC = \$2554.20 + \$9,450.00|TBC = \$12,004.20|

TREE SURVEY TABLE:

TAG#					DIST.	VALUE	DBH	ARB. REPORT			UNITS		UNITS
1	HARDWOOD	4.00	?	NEED ARBORIST ASSESSMENT, BOUNDARY TREE	0.00%	1.50					0		0
2	MAPLE	10.00	?	NEED ARBORIST ASSESSMENT, BOUNDARY TREE	0.00%	3.60					0		0
	 	 			0.00%	2,40		[0		0
3	HARDWOOD	6.00	?	NEED ARBORIST ASSESSMENT, BOUNDARY TREE				***					
4	OAK	24.00	?	NEED ARBORIST ASSESSMENT, BOUNDARY TREE	27.00%	6.60	X		✓		0		0
5	TWIN	6.00	?	NEED ARBORIST ASSESSMENT, BOUNDARY TREE	>30.00%	2.40					0		0
б	MAPLE	10,00	?	NEED ARBORIST ASSESSMENT, BOUNDARY TREE	15.00%	3.60	***	- 88			0		0
		 	?		0.00%	3.00	***************************************				0		0
<u>. </u>	MAPLE	8.00		NEED ARBORIST ASSESSMENT, BOUNDARY TREE							0		0
8	HARDWOOD	6.00	?	NEED ARBORIST ASSESSMENT, BOUNDARY TREE	0.00%	2.40							
9	HARDWOOD	6.00	?	NEED ARBORIST ASSESSMENT, BOUNDARY TREE	0.00%	2.40					0		0
10	BIRCH	10.00	?	NEED ARBORIST ASSESSMENT, BOUNDARY TREE	25.00%	3.60	100				0		0
11	HARDWOOD	6.00	?	NEED ARBORIST ASSESSMENT	>30.00%	2.40	***				0		0
					>30.00%	2.40		····			0		0
12	HARDWOOD	6.00	?	NEED ARBORIST ASSESSMENT						-			
13	HARDWOOD	18.00	?	NEED ARBORIST ASSESSMENT	>30.00%	5.70				V	0		0
14	HARDWOOD	6.00	?	NEED ARBORIST ASSESSMENT, BOUNDARY TREE	0.00%	2.40					0		0
15	HARDWOOD	8.00	?	NEED ARBORIST ASSESSMENT, BOUNDARY TREE	0.00%	3.00	88		- 1	·	0		0
		 	ļ		>30.00%	2.40				7	0		0
16	TRIPLE	6.00	?	NEED ARBORIST ASSESSMENT		ļ	<u> </u>			***************************************			
17	HARDWOOD	8.00	. ?	NEED ARBORIST ASSESSMENT	>30.00%	3.00					0		0
18	HARDWOOD	6.00	?	NEED ARBORIST ASSESSMENT	>30.00%	2.40				×.	0		0
19	HARDWOOD	6.00	?	NEED ARBORIST ASSESSMENT	>30.00%	2.40				4	0		0
20	PINE	10.00	?	NEED ARBORIST ASSESSMENT, BOUNDARY TREE	0.00%	3.60					0		0
		ļ			0.00%	3.60		ļ			0	 	0
21	PINE	10.00	?	NEED ARBORIST ASSESSMENT, BOUNDARY TREE		ļ	88			88			
22	PINE	8.00	?	NEED ARBORIST ASSESSMENT, BOUNDARY TREE	0.00%	3.00					0		a
23	PINE	12.00	?	NEED ARBORIST ASSESSMENT, BOUNDARY TREE	1.00%	4.20		100			0		0
24	PINE	10.00	?	NEED ARBORIST ASSESSMENT, BOUNDARY TREE	0.00%	3.60				888	0		0
******		ļ	?		>30.00%	3.60					0		0
25	HARDWOOD	10.00		NEED ARBORIST ASSESSMENT, BOUNDARY TREE	>30.00%	3.00					0		0
26	PINE	8.00	?	NEED ARBORIST ASSESSMENT, BOUNDARY TREE		<u> </u>							
27	PINE	15.00	?	NEED ARBORIST ASSESSMENT, BOUNDARY TREE	>30.00%	4.80	SS			@	0		0
28	PINE	15,00	?	NEED ARBORIST ASSESSMENT, BOUNDARY TREE	>30.00%	4,80		100		(3)	0		0
29	PINE	15.00	?	NEED ARBORIST ASSESSMENT, BOUNDARY TREE	>30,00%	4.80					0		0
	ļ	 		ļ	>30,00%	4.80		ļ			0	ļ	0
30	PINE	15.00	?	NEED ARBORIST ASSESSMENT, BOUNDARY TREE		ļ		<u> </u>					
31	PINE	15.00	7	NEED ARBORIST ASSESSMENT, BOUNDARY TREE	>30.00%	4.80				888	0		0
32	OAK	26.00	?	NEED ARBORIST ASSESSMENT	>30,00%	6.90	4	83	×.	4	6.90		0
33	OAK	36,00	?	NEED ARBORIST ASSESSMENT, BOUNDARY TREE	>30.00%	8.40	4		V		0		0
34	OAK	18.00	?	NEED ARBORIST ASSESSMENT	>30.00%	5.70					0		0
					ļ						7.50		0
35	OAK	30.00	?	NEED ARBORIST ASSESSMENT	>30,00%	7.50	4		¥	*			
36	OAK	8.00	7	NEED ARBORIST ASSESSMENT, BOUNDARY TREE.	>30.00%	3.00	100				0		0
37	OAK	6.00	?	NEED ARBORIST ASSESSMENT	>30.00%	2.40				4	0		0
38	OAK	10.00	?	NEED ARBORIST ASSESSMENT	>30.00%	3.60				7	0		0
					:>30.00%	3.00	888	888	888	7	0	466	0
39	OAK	8.00	?	NEED ARBORIST ASSESSMENT	ļ	<u> </u>				8020	ļ		
40	OAK	6.00	?	NEED ARBORIST ASSESSMENT	>30.00%	2.40				¥	0		0
41	OAK	8.00	?	NEED ARBORIST ASSESSMENT	>30.00%	3.00	- 100			4	0		0
42	OAK	15.00	?	NEED ARBORIST ASSESSMENT	>30.00%	4.80				4	0		0
				***************************************	>30.00%	5.70		·		V	0	88	0
43	OAK	18.00	?	NEED ARBORIST ASSESSMENT	ļ	ļ					0		0
44	OAK	10.00	?	NEED ARBORIST ASSESSMENT	>30.00%	3.60		- 88	- 1	×	ļ		
45	OAK	24.00	?	NEED ARBORIST ASSESSMENT	>30.00%	6.60	*		¥.	*	6.60		0
46	OAK	8.00	?	NEED ARBORIST ASSESSMENT	>30.00%	3.00				V	0		0
47	PINE	15.00	?	NEED ARBORIST ASSESSMENT, BOUNDARY TREE	>30.00%	4.80					0		0
	ļ		ļ		>30.00%	2.40				7	0		0
48	OAK	6.00	?	NEED ARBORIST ASSESSMENT		<u> </u>		888				888	
49	OAK	10.00	?	NEED ARBORIST ASSESSMENT	>30.00%	3.60				4	0		0
50	PINE	12.00	?	NEED ARBORIST ASSESSMENT, BOUNDARY TREE	>30.00%	4.20					0		0
51	PINE	8.00	7	NEED ARBORIST ASSESSMENT, BOUNDARY TREE	>30.00%	3.00				- 1	0		0
52	PINE	10.00	?	NEED ARBORIST ASSESSMENT, BOUNDARY TREE	>30.00%	3.60					0		0
		· 			ļ	<u> </u>			+		0	-	0
53	PINE	12.00	?	NEED ARBORIST ASSESSMENT, BOUNDARY TREE	>30.00%	4.20							
54	PINE	12.00	?	NEED ARBORIST ASSESSMENT, BOUNDARY TREE	>30.00%	4.20					0		0
55	PINE	12.00	?	NEED ARBORIST ASSESSMENT, BOUNDARY TREE	>30.00%	4.20					0		0
56	PINE	12.00	?	NEED ARBORIST ASSESSMENT, BOUNDARY TREE	>30.00%	4.20					0		0
57	ļ		?		>30.00%	5.70					0		0
	OAK	18.00		NEED ARBORIST ASSESSMENT, BOUNDARY TREE		4.20	+	-	ļ	·	0		0
58	PINE	12.00	?	NEED ARBORIST ASSESSMENT, BOUNDARY TREE	>30.00%								L
59	PINE	10.00	?	NEED ARBORIST ASSESSMENT, BOUNDARY TREE	>30.00%	3.60					0		0
60	PINE	10.00	?	NEED ARBORIST ASSESSMENT, BOUNDARY TREE	>30.00%	3,60		100	- 888		0		0
61	PINE	10.00	?	NEED ARBORIST ASSESSMENT, BOUNDARY TREE	>30.00%	3.60					0		0
			 		>30.00%	3.60				 	0		0
62	PINE	10,00	?	NEED ARBORIST ASSESSMENT, BOUNDARY TREE	<u> </u>	<u> </u>						·	
63	PINE	6.00	?	NEED ARBORIST ASSESSMENT, BOUNDARY TREE	>30.00%	2.40					0		0
64	OAK	18.00	?	NEED ARBORIST ASSESSMENT, BOUNDARY TREE	9.00%	5.70	- W	- 88	- 88		0		0
65	OAK	12.00	?	NEED ARBORIST ASSESSMENT, BOUNDARY TREE	17.00%	4.20					0		0
66	OAK	10.00	?	NEED ARBORIST ASSESSMENT	>30.00%	3.60				7	0		0
							 		+	1	0		0
67	OAK	6.00	?	NEED ARBORIST ASSESSMENT	>30.00%	4				V	4		ļ
68	OAK	18,00	?	NEED ARBORIST ASSESSMENT	>30.00%	5.70			- 100	V	0	- 88	0
69	OAK	12.00	?	NEED ARBORIST ASSESSMENT	>30.00%	4.20		88		1	0		0
70	OAK	12.00	?	NEED ARBORIST ASSESSMENT	>30.00%	4.20				1	0		0
			ļ	***************************************	>30.00%					ÿ			0
71	OAK	6.00	?	NEED ARBORIST ASSESSMENT	1					1000	1		<u> </u>
72	OAK	24.00	?	NEED ARBORIST ASSESSMENT, BOUNDARY TREE	>30.00%	1	4		*		0		0
73	OAK	18.00	?	NEED ARBORIST ASSESSMENT	>30.00%	5.70				₩	0	-	0
74	OAK	15.00	?	NEED ARBORIST ASSESSMENT	>30.00%	4.80				1	0		0
			7		>30.00%					7	 0		0
75	OAK	18.00	-	NEED ARBORIST ASSESSMENT			ļ	<u> </u>	<u> </u>	ļ			ļ
76	OAK	6.00	?	NEED ARBORIST ASSESSMENT	>30.00%					Y	0		0
77	OAK	18.00	DEAD	NEED ARBORIST ASSESSMENT	>30.00%	5.70	- 88			¥.	0	<u>l</u> 🕮	0
78	PINE	12.00	7	NEED ARBORIST ASSESSMENT	>30.00%	4.20				V	0		0
				NEED ARBORIST ASSESSMENT	>30.00%	4.20		9825	6555	1	0	8500	0
79	PINE	12,00	?		ļ					395	0	1 888	0
80	OAK	6.00	?	NEED ARBORIST ASSESSMENT, BOUNDARY TREE	26.00%								
81	OAK	30.00	?	NEED ARBORIST ASSESSMENT, BOUNDARY TREE	14.00%	7,50	*		X		0		0
82	PINE	10.00	?	NEED ARBORIST ASSESSMENT, BOUNDARY TREE	>30.00%	3.60					0		0
		1						nago rente a rente per mante a rente a	document of the second	REMOVED	24.00		1

PROJECT INFO:

ENGINEER:

LCE ENGINEERS, INC. 603 MACY DRIVE ROSWELL, GA 30075 LOVICK EVANS, PE 770.998.5763 REG #: 016630

SURVEYOR:

MULKEY ENGINEERS 1255 CANTON STREET SUITE G ROSWELL, GA 30075 WILLARD TUNNELL REG #: 3224 678.795.3600

OWNER/DEVELOPER:

DAHLHAUSER GROUP 171 VILLAGE PARKWAY BLDG 8A MARIETTA, GA 30067 MATT DAHLHAUSER 770.693.2390

24 HOUR CONTACT MATT DAHLHAUSER 404.567.0859

SITE AREA:

± 0.917 ACRES

TREE SAVE AREA:

± 0.00 ACRES

DISTURBED AREA: ± 0.917 ACRES

*FOR THE PURPOSES OF THE CALCULATIONS HEREIN, IT IS ASSUMED THAT THE DISTURBED AREA CONSISTS OF THE ENTIRE PROPERTY

NET SITE AREA:

± 0.917 ACRES

PROJECT ADDRESS: 1243 CANTON STREET, ROSWELL, GA 30075

LANDSCAPE ARCH:

CANOPY, LLC PO BOX 70052 MARIETTA, GA 30007 STEVEN A. HENRY, RLA 678.233.8466 REG #: LA001389 GSWCC #: 0000002999

FLOOD HAZARD NOTE:

THIS PROPERTY IS NOT LOCATED IN A 100 YEAR FLOOD HAZARD AREA BASED ON THE F.I.R.M. FOR THE AREA. THE MAP NUMBER FOR THIS AREA IS 13121COO61F, AND THE DATE OF SIAD MAP IS SEPTEMBER 18. 2013. THIS DETERMINIATION WAS MADE GRAPHICALLY DETERMINING THE POSITION OF THIS SITE ON SAID FIRM MAPS UNLESS OTHERWISE NOTED.

THE UTILITIES SHOWN HEREON ARE FOR THE CONTRACTOR'S CONVENIENCE ONLY. THERE MAY BE OTHER UTILITIES NOT SHOWN ON THESE PLANS. THE LANDSCAPE ARCHITECT ASSUMES NO RESPONSIBILITY FOR THE LOCATIONS SHOWN AND IT SHALL BE THE CONTRACTOR'S RESPONSIBILITY TO VERIFY ALL UTILITIES WITHIN THE LIMITS OF THE WORK. ALL DAMAGE MADE TO EXISTING UTILITIES BY THE CONTRACTOR SHALL BE THE SOLE RESPONSIBILITY OF THE CONTRACTOR..

Know what's below

Call before you dig.

CERTIFIED ARBORIST ASSESSMENT:

- ALL CALCULATIONS AND TREE SURVEY DATA HEREIN ARE SUBJECT TO CHANGE UPON RECEIPT OF CERTIFIED ARBORISTS' SPECIMEN TREE ASSESSMENT REPORT AND TREE
- ANY AND ALL NECESSARY REVISIONS WILL BE INCLUDED IN THE LAND DEVELOPMENT
- A TREE CARE AND MAINTENANCE PLAN WILL BE PROVIDED FOR ANY AND ALL SPECIMEN TREES "TO BE SAVED" OF WHICH HAVE CRZ IMPACT OF 30% OR LESS.

*TREE SAVE FENCE SHALL BE PLACED AT CRZ OF ANY AND ALL "TO BE SAVED" BOUNDARY TREES

**IMPACT ON BOUNDARY TREES EXISTS AND WILL NEED TO BE ASSESSED BY CITY OF ROSWELL ARBORIST FOR THE PURPOSES OF DETERMINING ADDITIONAL RECOMPENSE BEYOND THE CALCULATIONS PROVIDED HEREIN AND/OR THE NEED FOR A TREE CARE AND MAINTENANCE PLAN FOR SAID TREES.

GSWCC GEORGIA SOIL AND WATER CONSERVATION COMMISSION

Steven A Henry
Level II Certified Design Professional CERTIFICATION NUMBER 0000002999 ISSUED: 6/15/2012 EXPIRES: 6/15/2015


REVISIONS

PROJECT NO. 14-129 DATE: DRAWN BY: CHECKED BY:


TREE PROTECTION PLAN

SHEET 1 of 3

© 2014 CANOPY, LLC ALL RIGHTS RESERVE

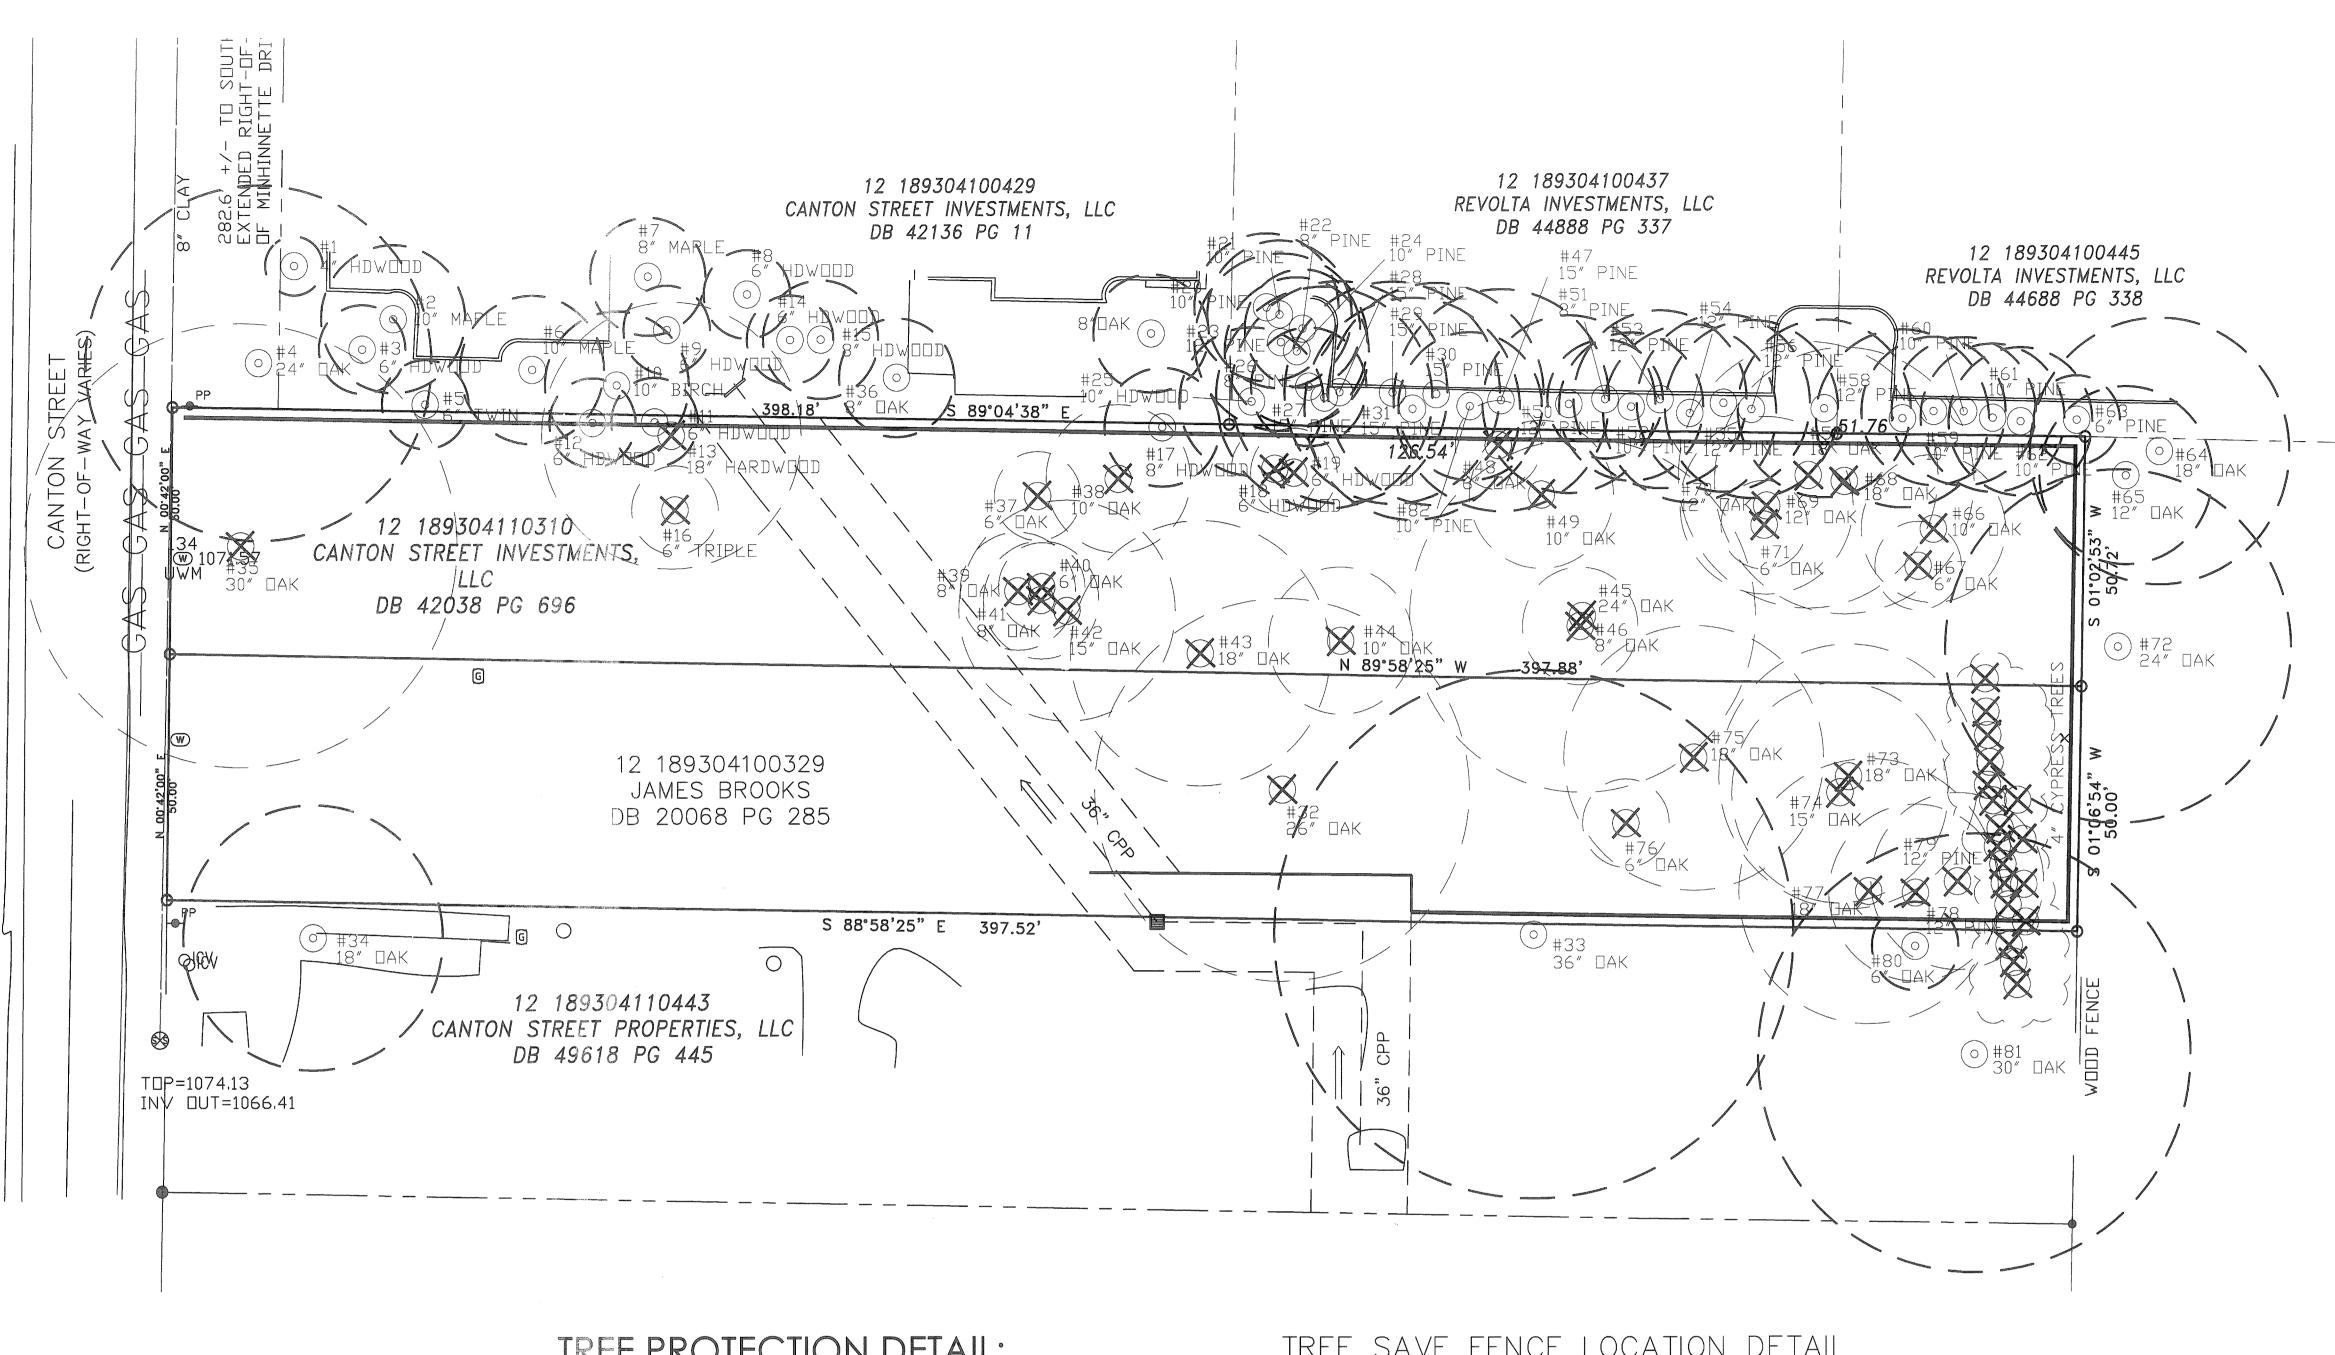

TREE PROTECTION DETAIL:

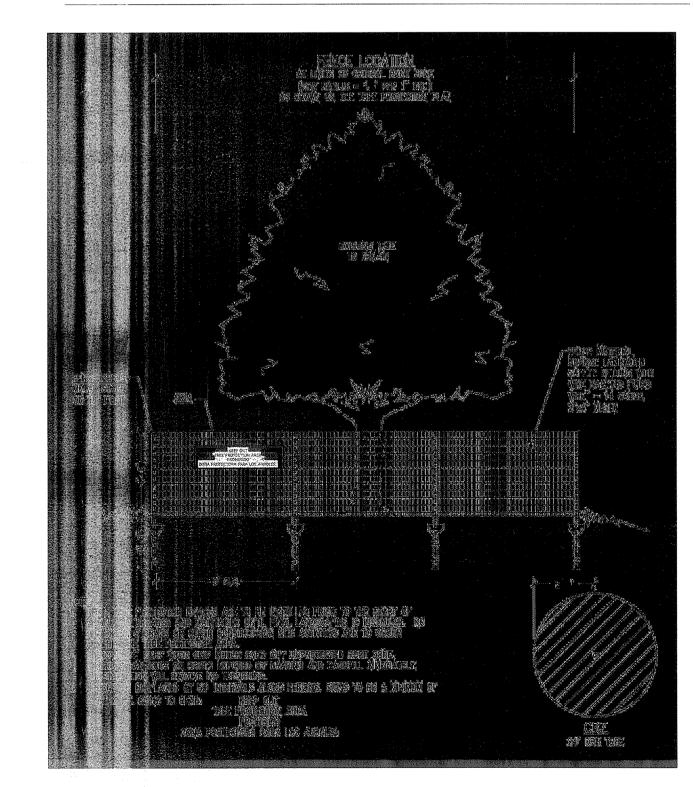

TREE SAVE FENCE LOCATION DETAIL

LAND DISTURBANCE

EROSION CONTROL E.C. SILT FENCE 2ND ROW (AS REQ'D) 1' MIN. SEPARATION TREE SAVE FENCE


LIMITS OF CLEARING


TREE SAVE AREA

*TREE SAVE FENCE SHALL BE PLACED AT CRZ OF ANY AND ALL "TO BE SAVED" BOUNDARY TREES

**IMPACT ON BOUNDARY TREES EXISTS AND WILL NEED TO BE ASSESSED BY CITY OF ROSWELL ARBORIST FOR THE PURPOSES OF DETERMINING ADDITIONAL RECOMPENSE BEYOND THE



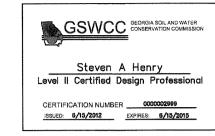

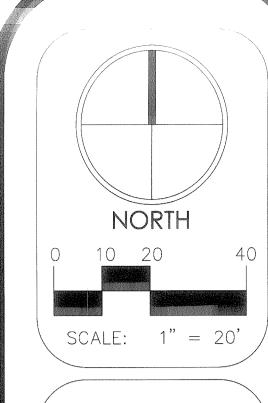

REVISIONS PROJECT NO. 14-129

DATE: 06.27.14 DRAWN BY: CHECKED BY:

TREE PROTECTION PLAN: REMOVALS


TP-102

SHEET 2 of 3


© 2014 CANOPY, LLC ALL RIGHTS RESERVED

CALCULATIONS PROVIDED HEREIN AND/OR THE NEED FOR A TREE CARE AND MAINTENANCE PLAN FOR SAID TREES.


TREE PLANTING DETAIL:

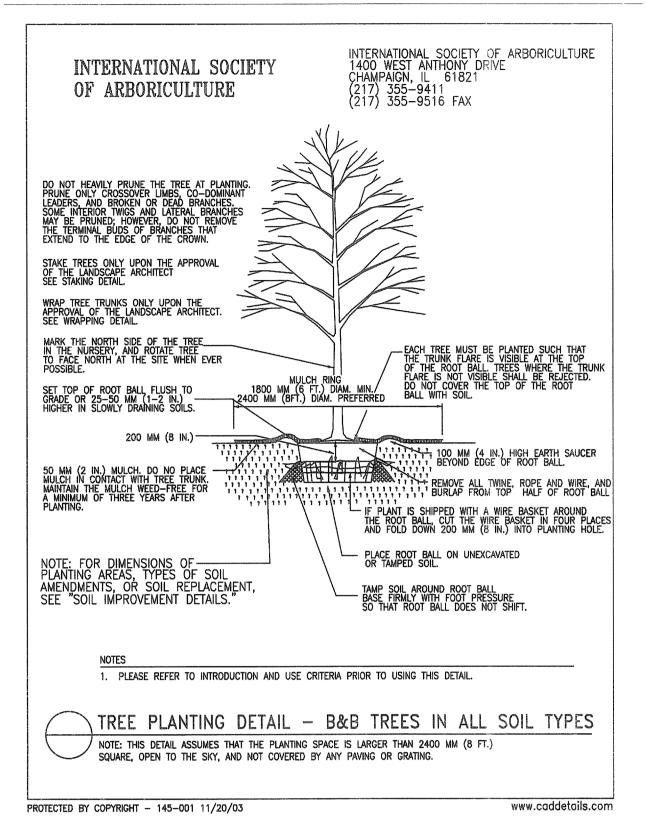

TREE STAKING DETAIL:

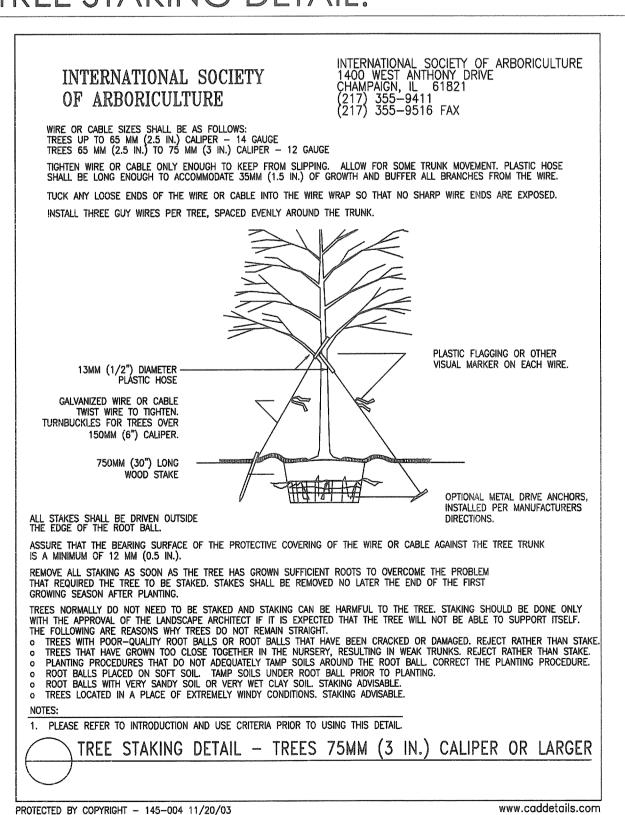


REPLACEMENT PLANT SCHEDULE:

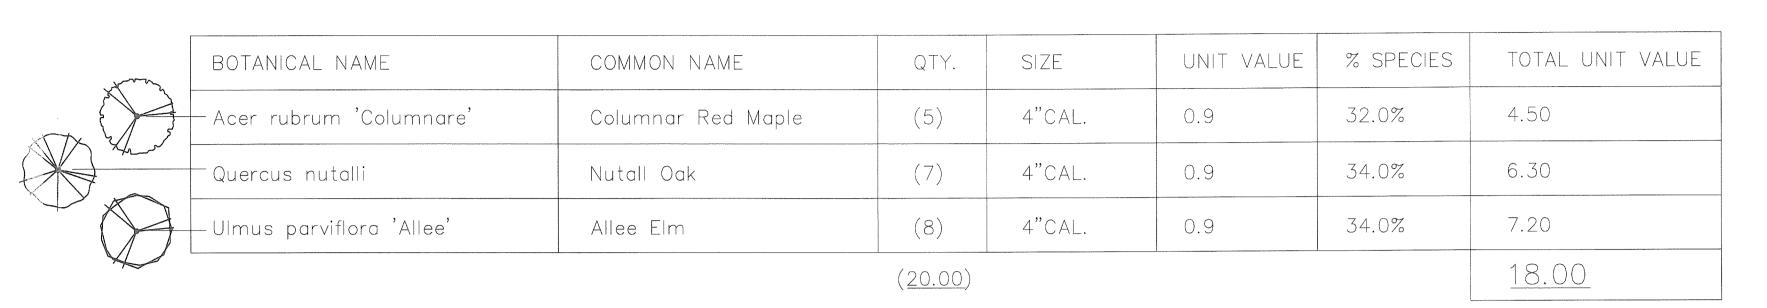





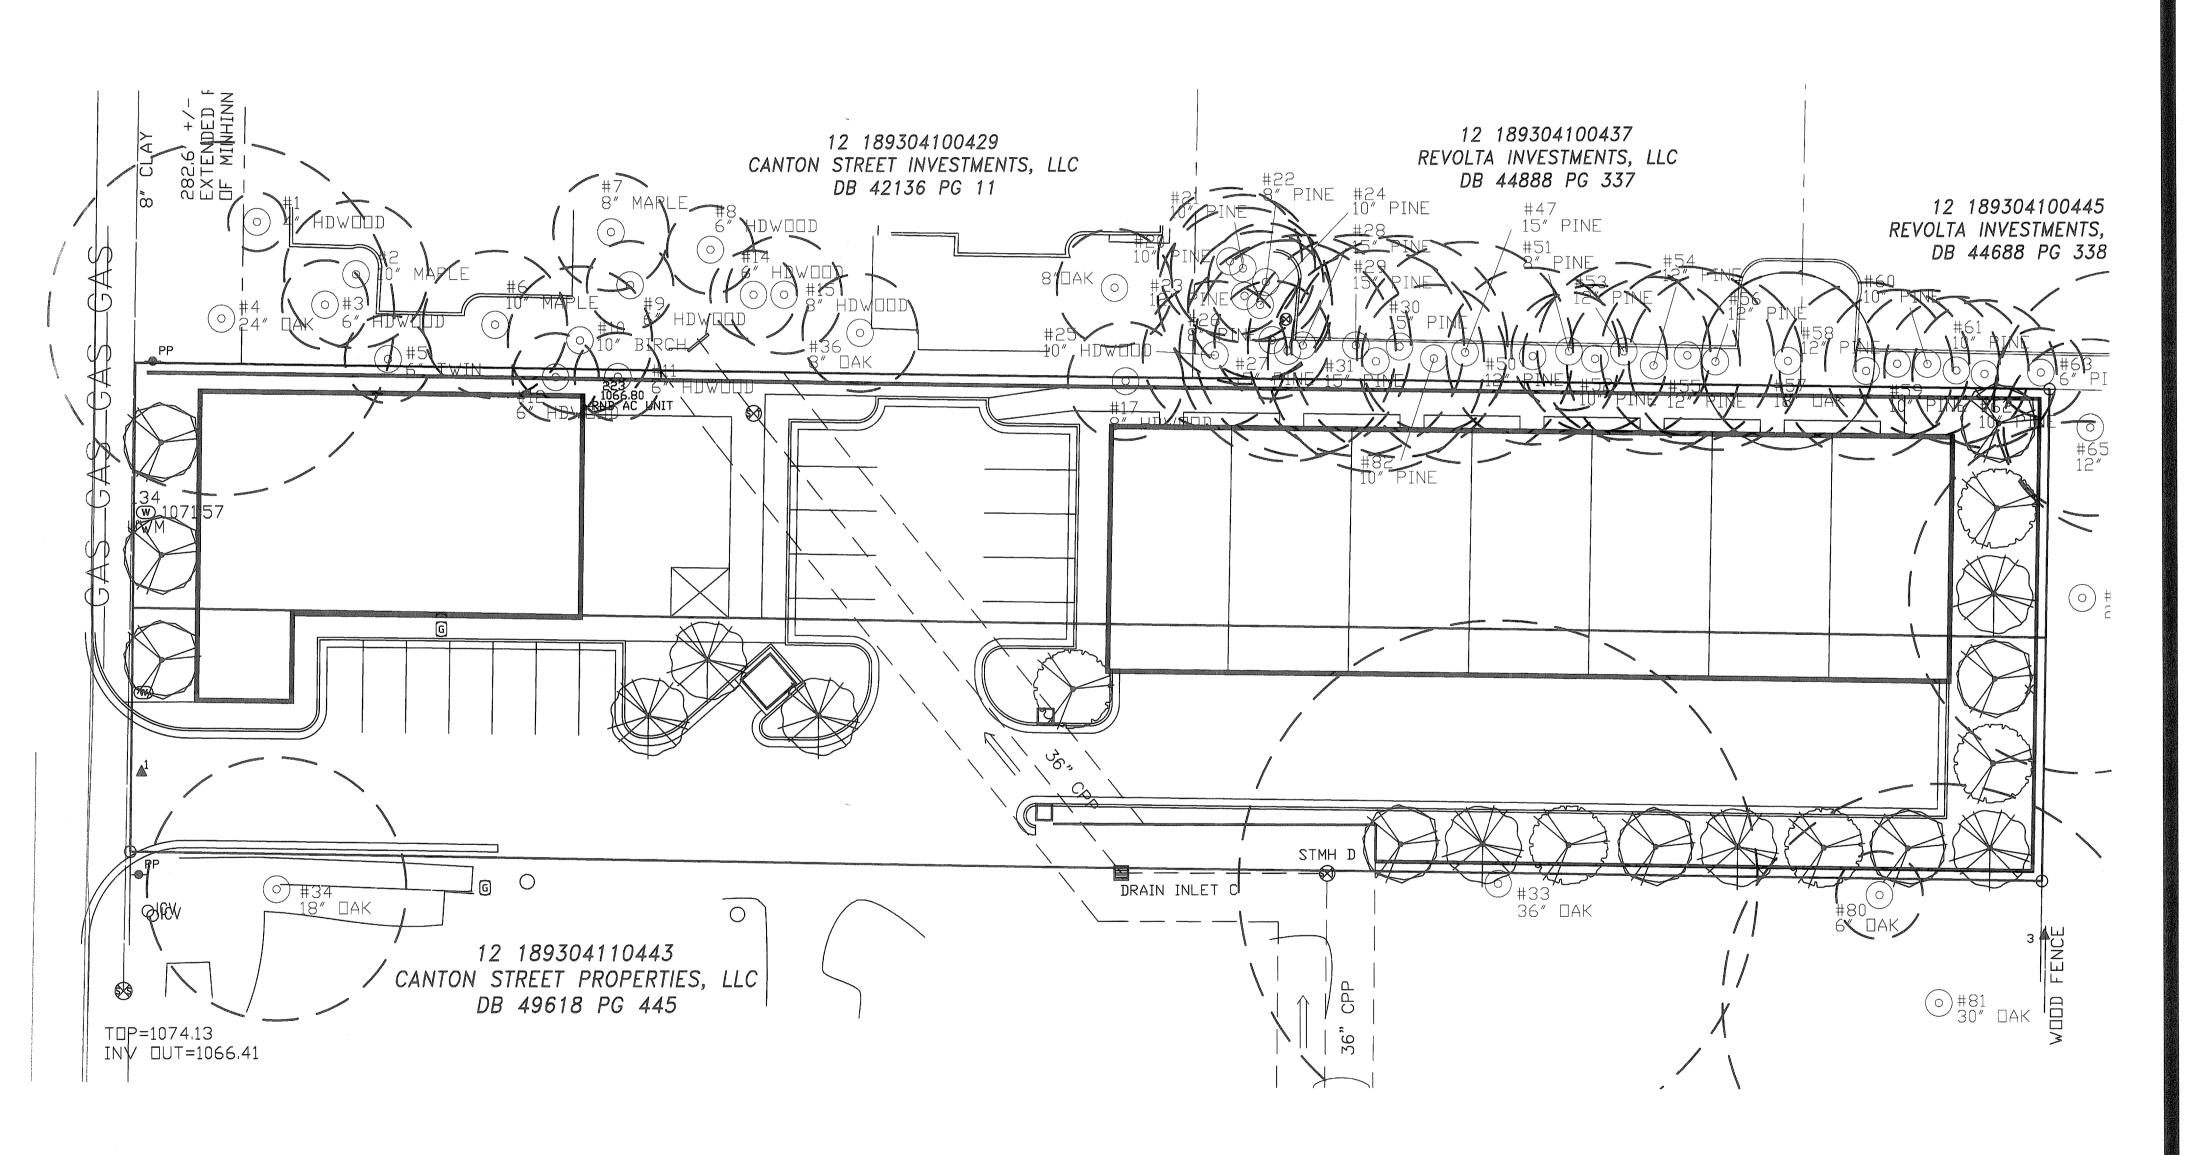

NORTH

O 10 20 4

SCALE: 1" = 20'

TY

Professional

CANDESCAPE AND PARTING PO BOX 70052

DRAWN BY: CHECKED BY: SAH

TREE

PROTECTION PLAN:

LANDSCAPE

TP-103

SHEET 3 of 3

© 2014 CANOPY, LLC ALL RIGHTS RESERVED