

NOTES

- The underground utilities shown have been located from field survey information and existing drawings. This surveyor makes no guarantee that the underground utilities shown comprise all such utilities in the area, either in service or abandoned. The surveyor further does not warrant that the underground utilities shown are in the exact location indicated although he does certify that they are located as accurately as possible from information supplied and to the surveyor's best knowledge are approximately as shown. The surveyor has not physically located the underground utilities.
- I have examined the Federal Emergency Management Agency Flood Insurance Rate Map for Fulton County, Georgia and incorporated Areas, Community Panel Number 13121C0051E, Panel 61 of 490, effective date June 22, 1998 and found NO portion of the property shown hereon to fall within a designated Flood Zone "A" (areas of 100 Year flood).
- The orthometric heights (elevations and contours) shown hereon were determined by GPS observations and were adjusted by Planners and Engineers Collaborative in June 2010, North American Datum of 1983 (NAD83), North American Vertical Datum of 1988 (NAVD88), Georgia West Zone State Plane Coordinates.
- The term "Certification" relating to professional engineering and land surveying services shall mean a signed statement based upon facts and knowledge known to the registrant and is not a guarantee or warranty, either expressed or implied.
- The underground utilities shown hereon were determined by locating point markings on the ground. The source of the markings is unknown and the accuracy of the markings cannot be verified.
- The proposed parcels shown hereon may or may not constitute a legal subdivision.
- No zoning information provided for building setbacks.

TITLE EXCEPTIONS

Chicago Title Insurance Company's commitment number 7230610-75061203 with an effective date of December 21, 2007 was used in the preparation of this survey and the listed exceptions are as follows:

- Permit for Anchors, Guy Poles and Wires to Georgia Power Company recorded in Deed Book 2381, Page 525, Fulton County, Georgia records, is vague in its description and cannot determine if it affects the subject property.
- Drainage rights as contained in that certain Right-of-Way Deed to Fulton County, Georgia recorded in Deed Book 2850, Page 386, aforesaid records, affects the subject property along Crossville Road, drainage rights cannot be plotted.
- Sewer Easement to Fulton County, Georgia recorded in Deed Book 9608, Page 296, aforesaid records, affects the subject property and is shown hereon.
- Limitation of access rights and easements contained in that certain Right-of-Way Deed to the Department of Transportation recorded in Deed Book 14050, Page 151, aforesaid records, affect the subject property as shown hereon, cannot determine where access is limited.
- Guardrail Easement to the City of Roswell, Fulton County, Georgia recorded in Deed Book 19394, Page 303, aforesaid records, affects the subject property and is shown hereon.
- Easement as contained in that certain Right-of-Way Deed to the City of Roswell, Fulton County, Georgia recorded in Deed Book 32868, Page 341, aforesaid records, affects the subject property and is shown hereon.
- Sewer Easement to Fulton County, Georgia recorded in Deed Book 32868, Page 347, as corrected by that certain Sanitary Sewer Easement to Fulton County recorded in Deed Book 34525, Page 227, aforesaid records, affects the subject property and is shown hereon.

LEGEND

- IRON PIN FOUND (in R/R-rod unless noted otherwise)
- IRON PIN SET (in R/R-rod unless noted otherwise)
- IRON PIN FOUND (open top pipe)
- IRON PIN SET (crimp top pipe)
- POINT
- CONCRETE MONUMENT FOUND
- SANITARY SEWER MANHOLE
- SANITARY SEWER LINE
- STORM DRAINAGE LINE
- DUAL STORM & SAN. SEWER LINE
- CATCH BASIN
- JUNCTION BOX
- DROP INLET
- HERR INLET
- CURB INLET
- POWER POLE
- POWER POLE W/ GUY WIRE
- OVERHEAD POWER / TELEPHONE LINE
- WATER VALVE
- GAS VALVE
- FIRE HYDRANT
- WATER LINE
- UNDERGROUND GAS LINE
- UNDERGROUND ELECTRIC LINE
- UNDERGROUND TELEPHONE LINE
- UNDERGROUND CABLE LINE
- LIGHT POLE
- EXISTING TREE
- (BOUND) CALLS PER DEED
- TH TOP OF WALL
- BW BOTTOM OF WALL
- HW WALL (TOP)
- TRANSFORMER
- BENCH MARK
- RCP REINFORCED CONCRETE PIPE
- B.S.L. BUILDING SETBACK LINE
- SIGN
- BOC BACK OF CURB

SANITARY SEWER INVERTS

NO.	TYPE	TOP	INVERT	INVERT	INVERT	OUT
1	DWC	1058.83	1042.9		1042.9	
2	DWC	1055.01	1044.8		1044.8	
3	DWC	1050.27	1042.5		1042.5	
4	DWC	1047.34	1041.3(2)	1040.7	1040.6	
5	DWC	1046.44	1038.0		1034.9	
6	DWC	1045.15	1034.6		1034.5	
7	DWC	1039.36	1032.5		1032.4	
8	DWC	1038.27	1029.7		1029.7	
9	DWC	1041.85	1037.3		1037.3	
10	DWC	1040.76	1035.0		1035.0	

STORM STRUCTURE INVERTS

NO.	TYPE	TOP	INVERT	INVERT	INVERT	OUT
1	DWC	1059.59			1043.8	
2	DWC	1075.83			1071.2	
3	DWC	1074.52	1069.4		1069.4	
4	DWC	1069.32	1062.9	1062.8(3)	1062.2	
5	DWC	1056.09	1047.0	1037.4	1037.4	
6	DWC	1052.47			1044.4	
7	DWC	1052.29	1051.4		1051.3	
8	DWC	1052.17			1028.6	
9	DWC	1051.3	1049.2		1049.0	
10	DWC	1052.20			1052.5	
11	DWC	1052.08	1056.6		1056.3	
12	DWC	1073.88			1068.9	
13	DWC	1071.94	1067.0		1066.5	
14	DWC	1071.35	1066.2		1066.5	
15	DWC	1069.74	1064.2	1064.1	1064.1	
16	DWC	1069.59	1062.0		1062.1	

LEGAL DESCRIPTION

ALL THAT TRACT OR PARCEL OF LAND lying and being in Land Lots 447, 448, 467 & 468 of the 1st District, 2nd Section, City of Roswell, Fulton County, Georgia and being more particularly described as follows:

BEGINNING at an iron pin found at the northeasterly end of the westerly right-of-way line of Mansell Road (Variable R/W) with the northeasterly right-of-way line of East Crossville Road, also known as State Route 92 (Variable R/W); thence along said miter South 75 degrees 05 minutes 11 seconds West a distance of 77.13 feet to a point; thence along said right-of-way line of East Crossville Road the following courses and distances: 223.54 feet along an arc of a curve to the right, said curve having a radius of 4,513.66 feet and a chord bearing and distance of North 64 degrees 06 minutes 36 seconds West 225.22 feet to an iron pin found (1" Rebar) on the Land Lot Line common to Land Lots 448 & 467; thence leaving said Land Lot Line and continuing along said right-of-way line of East Crossville Road the following courses and distances: North 60 degrees 41 minutes 16 seconds West a distance of 134.12 feet to a point; thence North 60 degrees 42 minutes 03 seconds West a distance of 171.47 feet to a concrete monument found; thence North 28 degrees 27 minutes 34 seconds East a distance of 24.16 feet to a concrete monument found; thence North 43 degrees 16 minutes 46 seconds West a distance of 51.65 feet to a concrete monument found; thence North 60 degrees 11 minutes 45 seconds West a distance of 20.22 feet to a concrete monument found; thence North 24 degrees 13 minutes 42 seconds West a distance of 67.72 feet to a point; thence 138.03 feet along an arc of a curve to the left, said curve having a radius of 430.00 feet and a chord bearing and distance of North 02 degrees 29 minutes 05 seconds East 137.44 feet to a point; thence leaving said right-of-way line of East Crossville Road North 16 degrees 56 minutes 30 seconds East a distance of 45.31 feet to a point; thence North 27 degrees 06 minutes 31 seconds East a distance of 87.66 feet to a point; thence North 01 degrees 01 minutes 27 seconds West a distance of 26.50 feet to an iron pin found (1/2" Open Top Pipe); thence leaving said Land Lot Line South 88 degrees 30 minutes 04 seconds East a distance of 394.48 feet to a point on said westerly right-of-way line of Mansell Road; thence along said right-of-way line the following courses and distances: South 01 degrees 26 minutes 17 seconds West a distance of 237.01 feet to a point; thence South 12 degrees 17 minutes 28 seconds West a distance of 85.83 feet to an iron pin found; thence South 01 degrees 23 minutes 21 seconds West a distance of 82.62 feet to an iron pin found; thence South 11 degrees 32 minutes 32 seconds West a distance of 80.20 feet to a point; thence South 02 degrees 37 minutes 12 seconds West a distance of 51.48 feet to a point; thence South 03 degrees 20 minutes 05 seconds East a distance of 76.69 feet to a point; thence 357.48 feet along an arc of a curve to the right, said curve having a radius of 1,440.00 feet and a chord bearing and distance of South 14 degrees 00 minutes 40 seconds West 356.49 feet to an iron pin found and the POINT OF BEGINNING.


Said tract containing 11.493 acres.

KINGSMILL VILLAGE CONDO
CONDO PB 8 / PG 85

(N86°01'41"E 287.88')
N86°01'21"E
284.93'

1/2" OT PIPE

HELD DEED CALLS PER DB 47093 / PG 102 SINCE CREEK HAS CHANGED COURSE AND WAS NOT CALLED OUT AS THE PROPERTY LINE.

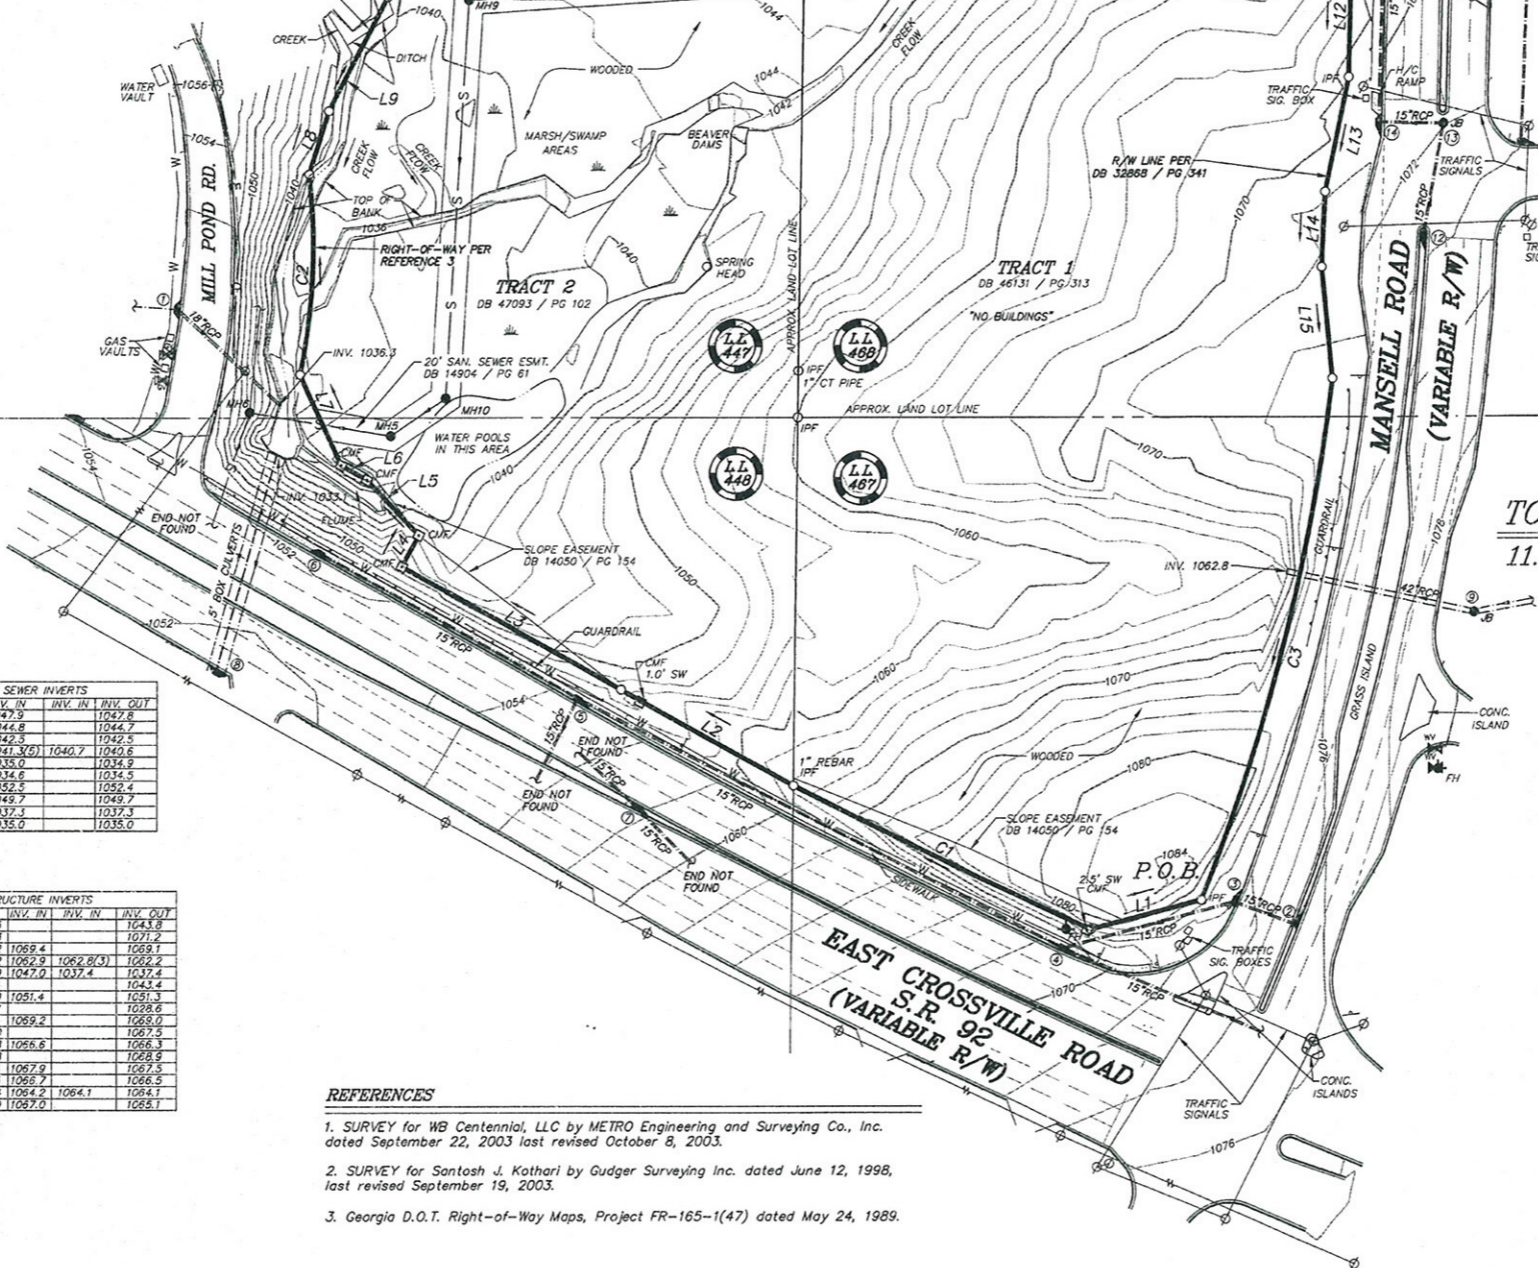

TOTAL AREA
11.493 ACRES

CALL TABLE

LINE	LENGTH	BEARING	(DEED CALLS)
L1	77.13'	S75°05'11"W	(S75°07'44"W 77.18')
L2	134.12'	N60°41'16"W	(N60°41'23"W 134.11')
L3	171.47'	N60°42'03"W	(N60°41'23"W 171.42')
L4	24.16'	N28°27'34"E	(N29°18'35"E 25.00')
L5	51.65'	N43°16'46"W	(N43°09'23"W 52.20')
L6	20.22'	N60°11'45"W	(N60°41'23"W 20.00')
L7	67.72'	N24°13'42"W	(N24°21'05"W 67.50')
L8	45.31'	N16°56'30"E	(N16°56'31"E 45.31')
L9	87.66'	N27°06'31"E	(N27°06'32"E 87.66')
L10	26.50'	N01°01'27"W	(N02°20'37"W 26.54')
L11	95.83'	S12°17'26"W	(S12°18'30"W 95.91')
L12	82.62'	S01°23'21"W	
L13	80.20'	S11°32'32"W	
L14	51.48'	S02°37'12"W	
L15	76.69'	S05°20'05"E	

CURVE TABLE

CURVE	LENGTH	RADIUS	BEARING	CHORD	(DEED CALLS)
C1	225.24	4513.66	N84°06'36"W	225.22	(225.23' 4513.66' 225.21' N84°03'34"W)
C2	138.03	430.00	N02°29'05"E	137.44	(138.03' 430.00' 137.44' N02°29'05"E)
C3	367.48	1440.00	S14°00'40"W	366.49	

This is to certify that this map or plot and the survey on which it is based were made in accordance with "Minimum Standard Detail Requirements for ALTA/ACSM Land Title Surveys," jointly established and adopted by ALTA, ACSM, and NSPS in 2005, and includes Items 1, 3, 4, 5, 6 and 8-11 of Table A thereof. Pursuant to the Accuracy Standards as adopted by ALTA, NSPS and ACSM and in effect on the date of this certification, undersigned further certifies that in my professional opinion, as a land surveyor registered in the State of Georgia, the Relative Positional Accuracy does not exceed that which is specified therein.





DATED: 6/18/10
William H. Kelly, Jr., Ge. R.L.S. No.2469

ALTA/ACSM LAND TITLE SURVEY
DRAWN BY: JKH
CHECKED BY: JKH
DATE: 06/18/10
SCALE: 1" = 60'

RECEIVED
JUL 16 2010
City of Roswell
Community Development Dept.

FOR
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CITY OF ROSWELL

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TREE DENSITY CALCULATIONS

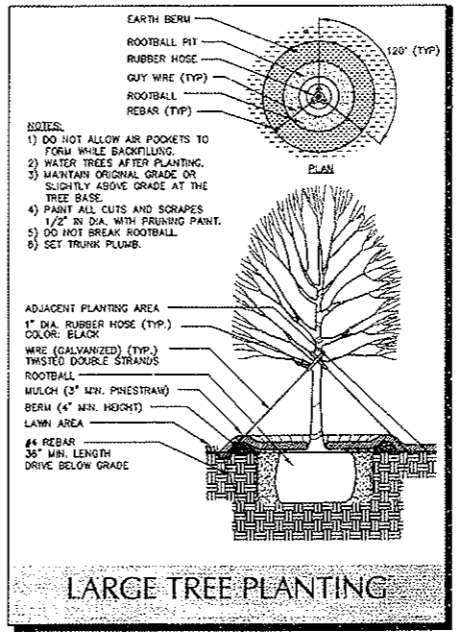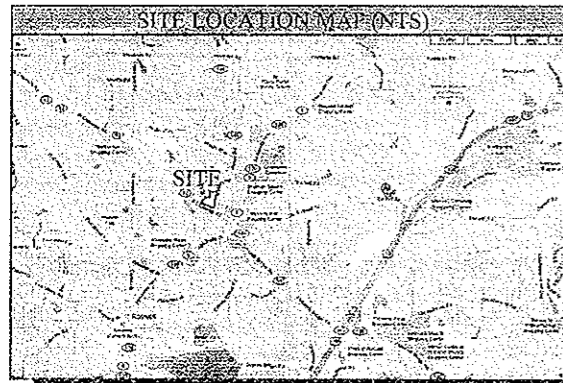SITE DATA

TOTAL SITE AREA	11.493 ACRES
TRACT (1) SITE AREA (RACETRACK)	1.996 ACRES
TRACT (2) SITE AREA (CROCCERY STORE)	2.21 ACRES
TOTAL DISTURBED SITE AREA	4.196 ACRES

TREE REPLACEMENT REQUIREMENTS:

30 UNITS PER ACRE
 4.196AC X 30 UNITS = 125.88 UNITS REQUIRED (SDF)
 *142.0 UNITS OF EXISTING TREES TO BE SAVED (EDF)

REPLACEMENT DENSITY FACTOR:

SITE DENSITY FACTOR (SDF)	125.88 UNITS
EXISTING DENSITY FACTOR (EDF)	142.0 UNITS
REPLACEMENT DENSITY FACTOR (RDF)	16.12 UNITS

TREE DENSITY COMPLIANCE:

EXISTING DENSITY FACTOR	142.0 UNITS
REPLACEMENT DENSITY FACTOR	+ 25.0 UNITS
SITE DENSITY FACTOR PROVIDED	167.0 UNITS
SITE DENSITY FACTOR REQUIRED	125.88 UNITS

LANDSCAPE STRIP CALCULATIONS

REQUIREMENT: 10' MINIMUM LANDSCAPE STRIP
 (1) SHADE TREE / (10) SMALL SHRUBS PER 35' LINEAR FEET OF STREET FRONTAGE

LANDSCAPE STRIP ALONG EAST CROSSVILLE ROAD (S.R. 92):

530.6 LF OF STREET FRONTAGE	
29 LF OF DRIVEWAY	
501.6 LF OF STREET FRONTAGE	

*501.6 / 35 = 14.3 = (14) SHADE TREES REQUIRED
 *14 X (10) SMALL SHRUBS = (140) SMALL SHRUBS REQUIRED

LANDSCAPE STRIP ALONG MANSELL ROAD:

991.5 LF OF STREET FRONTAGE	
363.4 LF OF TREESAVE AREA ALONG FRONTAGE	
40 LF OF DRIVEWAY	
588.1 LF OF STREET FRONTAGE	

*588.1 / 35 = 16.8 = (17) SHADE TREES REQUIRED
 *17 X (10) SMALL SHRUBS = (170) SMALL SHRUBS REQUIRED

Mansell Road at State Route 92
 A MASTER PLANNED COMMERCIAL PROJECT

FOR:
Easlan Capital - c/o Fletcher Crossing
 3328 Peachtree Road NE
 Suite 300
 Atlanta, Georgia 30326
 PHONE: 404-574-5913

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REVISIONS:

NO.	DATE	BY	DESCRIPTION

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SHEET TITLE
TREE REPLACEMENT PLAN

SCALE: 1" = 40'
 DATE: June 18, 2010
 PROJECT: 10020.00

TREE REPLACEMENT PLANT MATERIAL

SYMBOL	PERCENTAGE	QUAN	KEY	BOTANICAL NAME	COMMON NAME	SIZE	UNITS	TOTAL UNITS
AR	38%	19	AR	Acer Rubrum 'Frankford'	Red Sunset Maple	3" cal.	0.5	9.5
CJ	14%	7	CJ	Cryptomeria japonica 'Yoshino'	Yoshino Cryptomeria	3" cal.	0.5	3.5
OP	24%	12	OP	Quercus phellos	Willow Oak	3" cal.	0.5	6.0
UA	24%	12	UA	Ulmus parvifolia 'Emerl'	Athens Elm	3" cal.	0.5	6.0
TOTAL		50						25.0 UNITS

SHRUBS, GROUND COVER

SYMBOL	PERCENTAGE	QUAN	KEY	BOTANICAL NAME	COMMON NAME	SIZE	HEIGHT	SPACING
CD	15.6%	49	CD	Cynodon dactylon	Bermuda Grass	SOD	N/A	N/A
IP	8.3%	26	IP	Illicium parviflorum	Anise	5 gal.	30"-36"	4' O.C.
JP	16.8%	53	JP	Juniperus davurica expansa	Parson's Juniper	3 gal.	18"-24"	4' O.C.
LC	14.3%	45	LC	Loropetalum chinense 'Ruby'	Ruby Loropetalum	5 gal.	30"-36"	4' O.C.
MML	25.4%	80	MML	Miscanthus sinensis 'Morning Light'	Morning Light Miscanthus	5 gal.	30"-36"	4' O.C.
RJ	19.6%	62	RJ	Raphelepis indica	Indian Hawthorn	5 gal.	30"-36"	4' O.C.
RK			RK	Rosa 'Knockout'	Knockout Rose	5 gal.	30"-36"	4' O.C.
TOTAL		315						

811
 Know what's below.
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24 HOUR CONTACT:
JESSE SHANNON @ 404-442-7888


STATE OF GEORGIA
 PROFESSIONAL ENGINEER
 JESSE SHANNON
 7-6-10

TPR3
 SHEET


EXTERIOR FINISHES SCHEDULE			
KEY	MATERIAL / MFG.	COLOR / NO.	NOTES
A1	GRAVEL STOP BY FIRESTONE	SLATE GRAY	
A2	MODULAR BRICK	OLD WILLIAMSBURG	
A3	MODULAR BRICK	OLD WILLIAMSBURG	PILASTERS AND WINDOW SILLS
A4	STOREFRONT	ANODIZED ALUM.	RE: DWG. A602
A5	TOWER PANELS BY PAC-CLAD	SLATE GRAY ALUMINUM .040 FLUSH PANELS	RE: DWG. A301/A302
A6	METAL SOFFIT PANELS BY PAC-CLAD	ANODIZED ALUM. PAC-750 HALF VENTED PANELS	RE: DWG. A301-A304
A7	EXTERIOR PAINT BY SHERWIN-WILLIAMS	PT-3 / CL-5	
A8	NOT USED		
A9	ALUMINUM COMPOSITE PANEL	BRIGHT SILVER	PROVIDE PANEL JOINTS ABOVE WINDOW AS SHOWN ON DRAWINGS
A10	HANGER ROD	STAINLESS STEEL ROD AND TURNBUCKLE, PT-3 / CL-5 CLEVIS, KNIFE PL AND END PL	
A11	BLRD-2	PT-3 / CL-4	
A12	BLRD-4		1/2" DIA. A 36" (H) DOME BOLLARD MODEL #TF4027
A13	GUARD RAIL TYPE "A"	PT-3 / CL-5	RE: A3/A503
A14	GUARD RAIL TYPE "B"	PT-3 / CL-5	RE: A3/A503
A15	CART RAIL & STARTER POST	GALVANIZED	
A16	DOCK LEVELER / SEAL AND BUMPERS	LEVELER - FACTORY FINISH / SEAL AND BUMPERS - FACTORY FINISH - BLACK	
A17	CONTROL JOINT		AT EACH PILASTER TYP. RE: DWG. A504
A18	OVERFLOW SCUPPER	PT-3 / CL-5	RE: C3/A503
A19	FOOD MARKET SIGNAGE	BY SIGN VENDOR	14'-2 3/4" w. x 1'-6" h.
A20	ALDI TOWER SIGN	BY SIGN VENDOR	5'-0" w. x 6'-0 1/2" h.
A21	CONCRETE CART BUMPER	NATURAL	SEE STRUCTURAL DWGS
E1	EXIT DISCHARGE LIGHT	EXTERIOR REMOTE EMERGENCY FIXTURE	MOUNT @ 7'-6" A.F.F.
E2	WALL SCONCE	FACTORY PAINT - PLATINUM SILVER	MOUNT @ 7'-6" A.F.F.
E3	EXTERNAL SIREN	FACTORY FINISH	MOUNT @ 12'-0" A.F.F.
E4	UTILITY METERING & C.T.	FACTORY FINISH	SEE ELECTRICAL
E5	EXTERIOR LIGHT	WALL PACK	E5 - MOUNT @ 12'-0" A.F.F. E5G - MOUNT @ 10'-0" A.F.F.
E6	EXTERIOR DUPLEX RECEPTACLE	FACTORY FINISH	MOUNT @ 1'-6" A.F.F.
F1	FIRE DEPT. CONNECTION	FACTORY FINISH	SEE FIRE PROTECTION DWG.
M1	VENT GRILL	FACTORY FINISH	SEE MECHANICAL DWGS
P1	HOSE BIB	FACTORY FINISH	SEE PLUMBING DWGS
XX	STOREFRONT KEY	ANODIZED ALUMINUM	SEE A602

SIGNAGE			
DESCRIPTION	QUANTITY	SQ. FT. PER SIGN	TOTALS
TOWER SIGN	2	31.2	62.4
FOOD MARKET SIGN	2	21.3	42.6
TOTAL SIGNAGE			105.0


SIGNAGE IS SHOWN FOR REFERENCE ONLY AND SHALL BE UNDER SEPARATE PERMIT SUBMITTAL

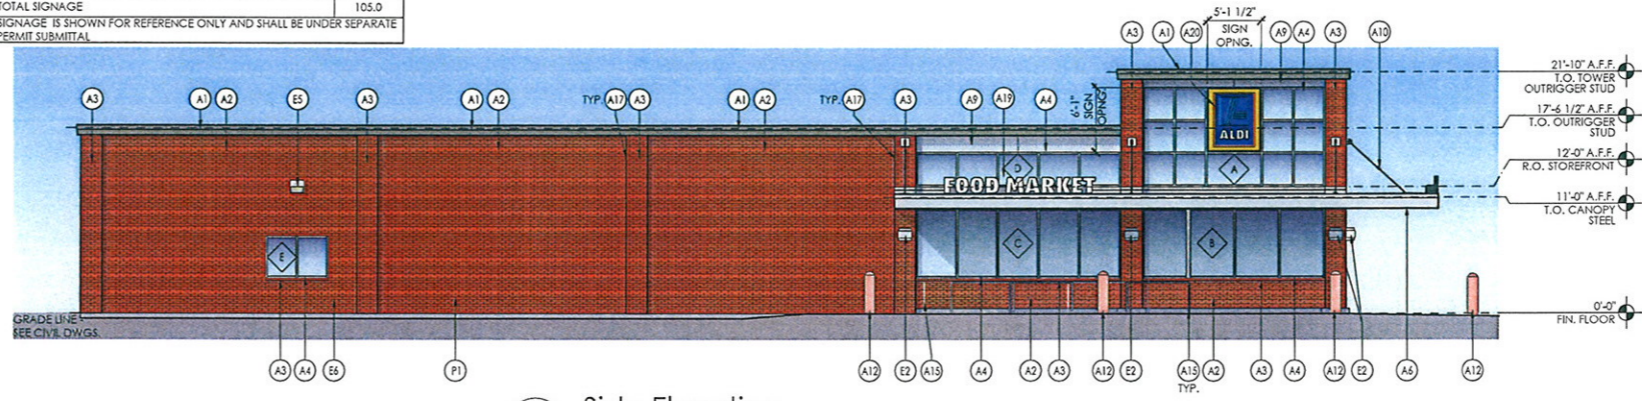


4 Side Elevation
SCALE: 1/8" = 1'-0"

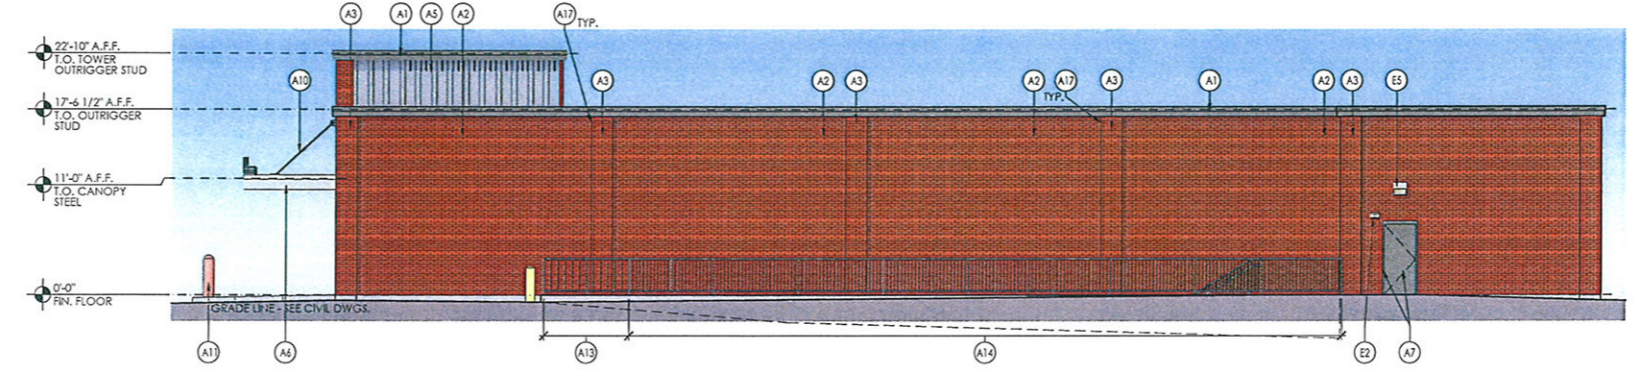

3 Side Elevation
SCALE: 1/8" = 1'-0"

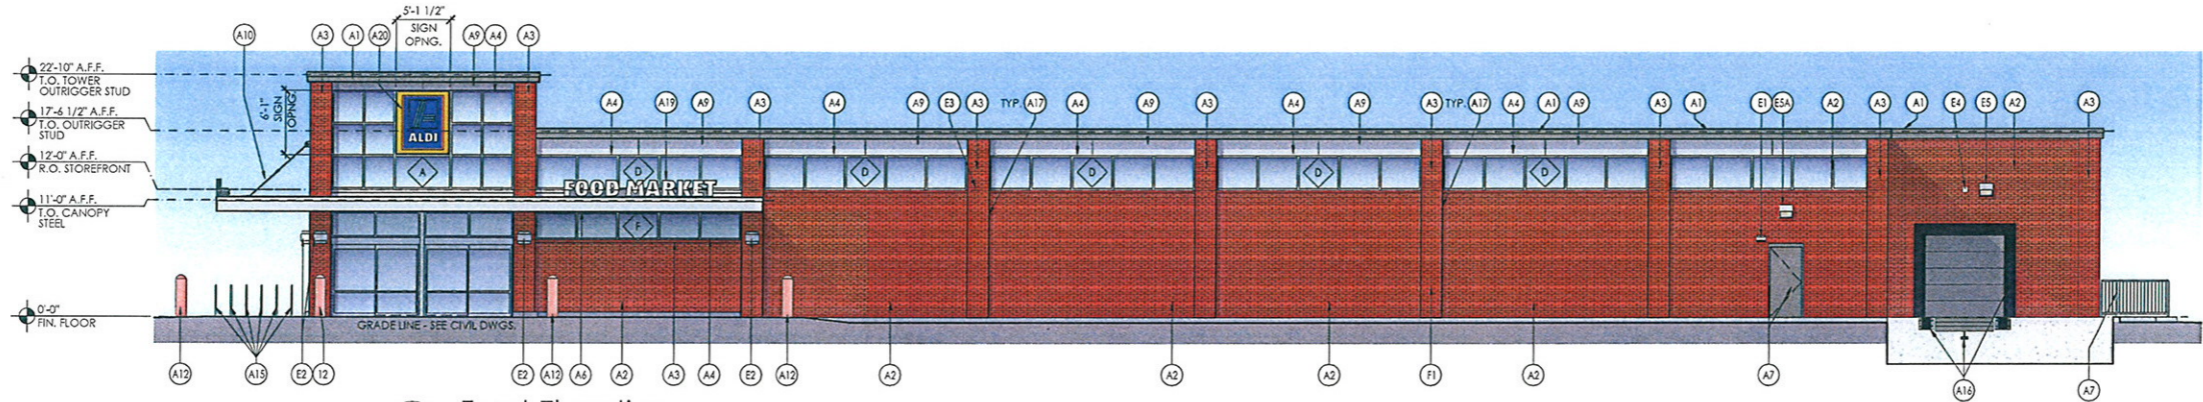

2 Front Elevation
SCALE: 1/8" = 1'-0"

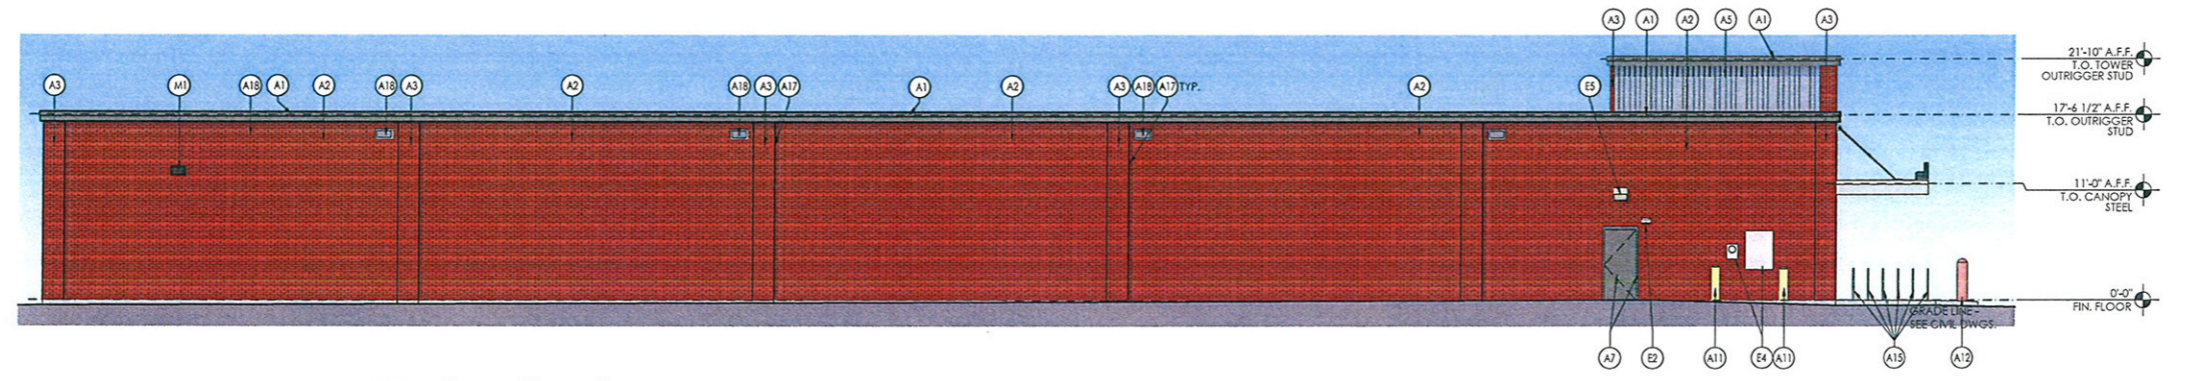

1 Rear Elevation
SCALE: 1/8" = 1'-0"

Issued:	Date:
A	
B	
C	
D	

Revisions:	Date:
1	
2	
3	
4	
5	


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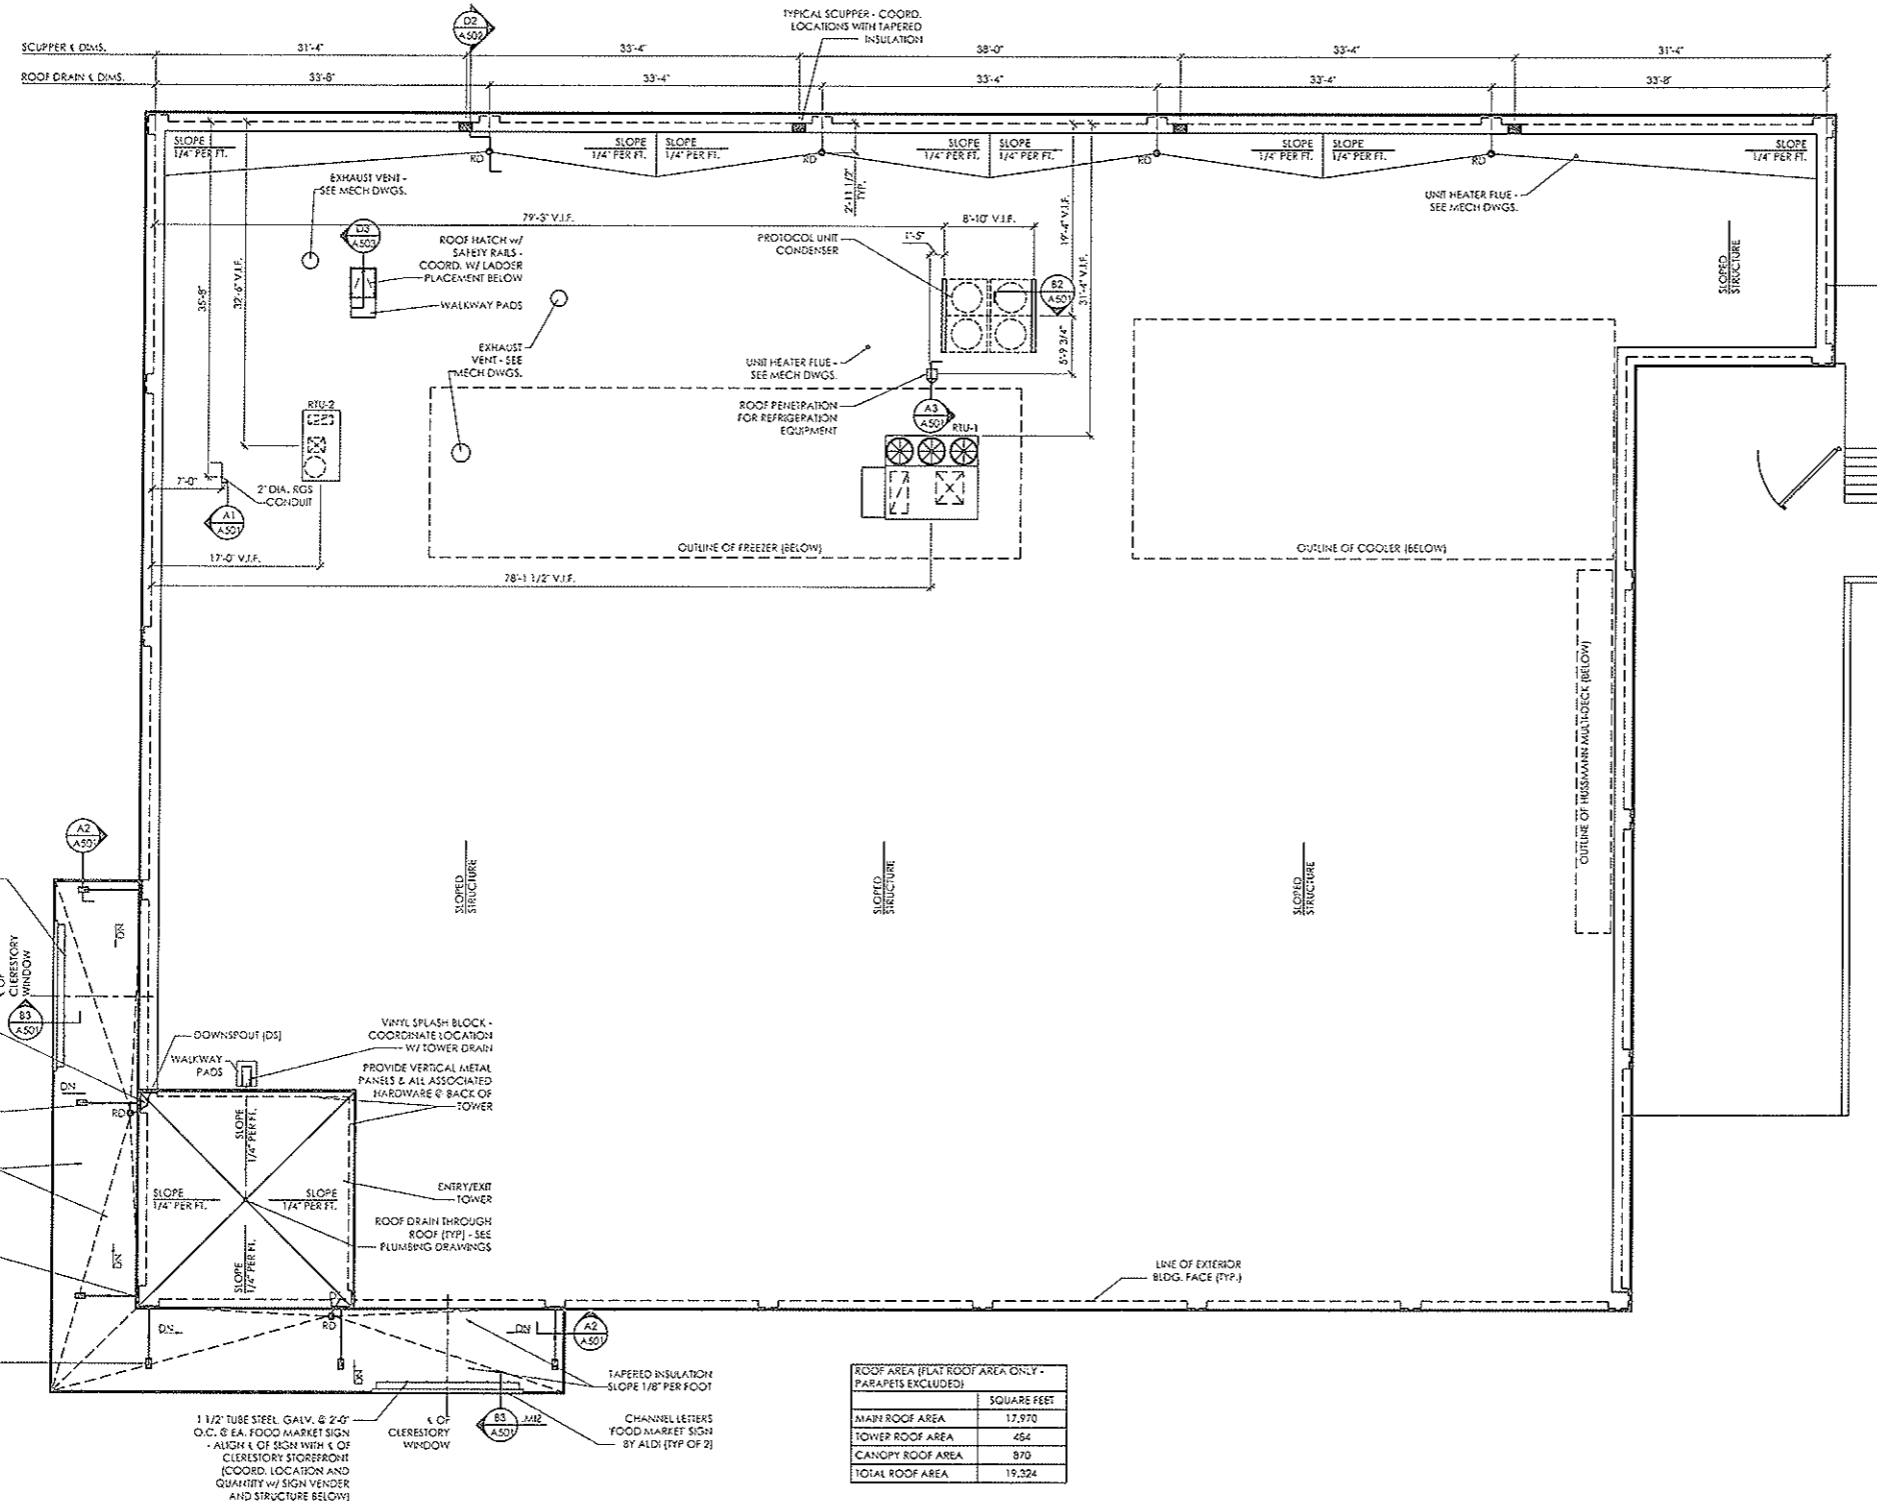


APD Engineering & Architecture, PLLC
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ALDI Inc.
Roswell, GA
Mansell Rd & Crossville Rd
Roswell, GA 30076
Fulton County
Project Name & Location:

Exterior Elevations Drawing Name:	Project No. 10-0165A
Date: 06/23/10	
Type: LHSD-V3	
Drawn By: JCW	A-201
Scale: As Noted	Drawing No.



ROOF AREA (FLAT ROOF AREA ONLY - PARAPETS EXCLUDED)	SQUARE FEET
MAIN ROOF AREA	17,970
TOWER ROOF AREA	454
CANOPY ROOF AREA	870
TOTAL ROOF AREA	19,324

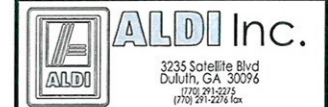1 Roof Plan
SCALE: 1/8" = 1'-0"



Issued:	Date:
A Issued for Use/Reference	06/15/10
B	
C	
D	
Revisions:	
1	
2	
3	
4	
5	

These drawings are preliminary drawings that must be adapted for the specific conditions, including but not limited to, wind loads, soil conditions and any other requirements as necessitated by local codes, regulations and ordinances. With the approval of an ALDI Director of Real Estate, a licensed architect or engineer shall make any modifications to the drawings necessary to meet all applicable regulations and codes.

Seal	Seal
PROJECT ARCHITECT/ENGINEER	DATE
PROJECT LEAD	DATE
PROJECT DESIGNER	DATE

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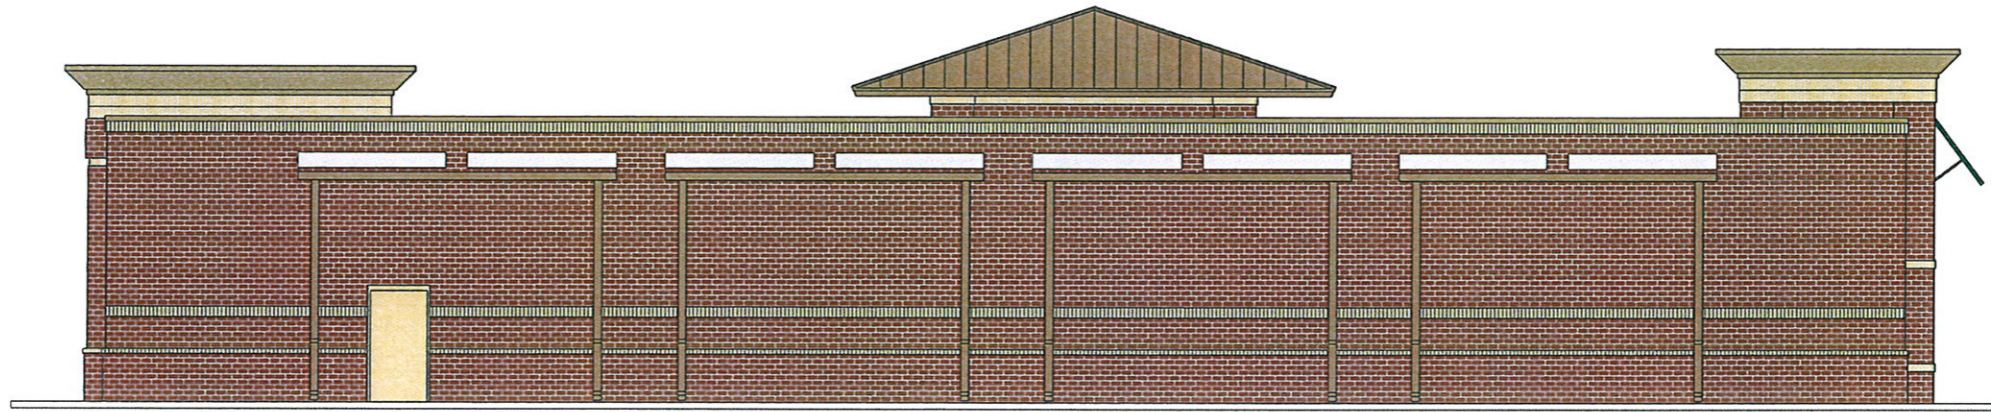
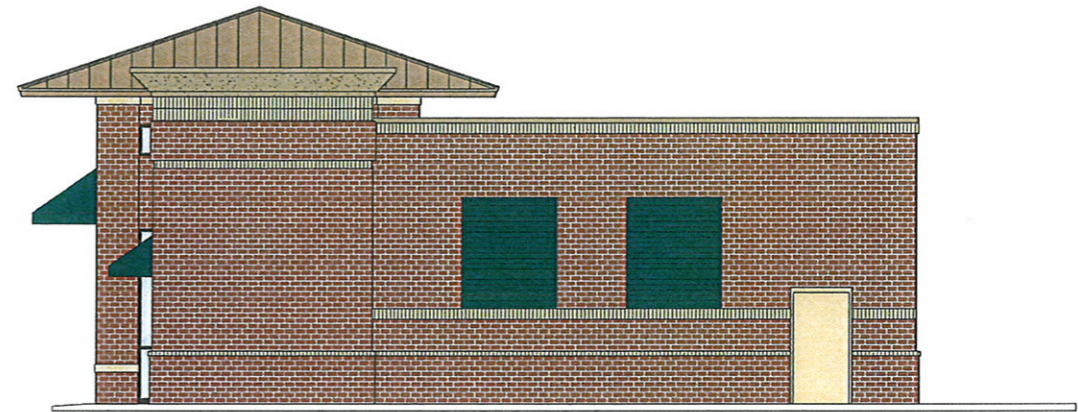
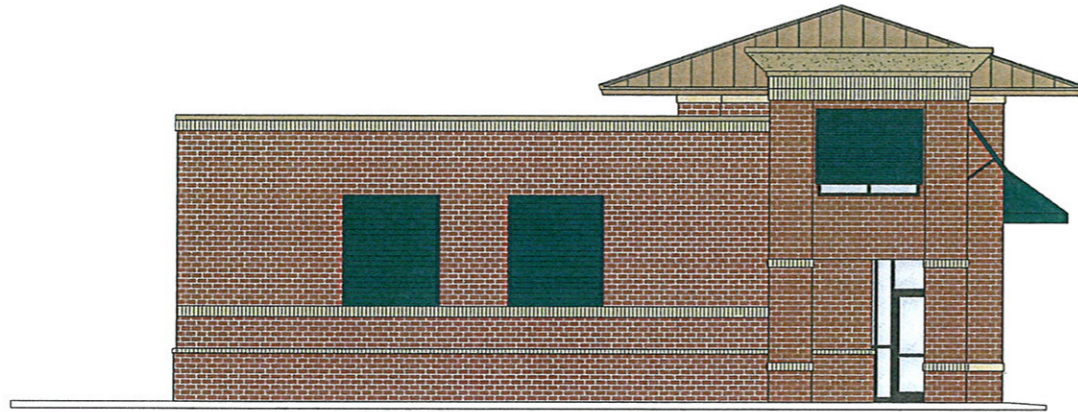
DO NOT SCALE PLANS
Copying, printing, software and other processes result in production errors. These errors can result in the actual paper or layout. Therefore, looking at this drawing may be inaccurate. Contact APD Engineering with any need for additional dimensions or clarifications.


APD Engineering & Architecture, PLLC
615 Fishers Run
Victor, NY 14564
585-742-2222
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www.apd.com

ALDI Inc.
3235 Soletta Blvd
Duluth, GA 30096
770-995-9976
770-995-9976 fax


ALDI Inc.
Roswell, GA
Mansell Road and Crosville Road
Roswell, GA 30076
Fulton County
Project Name & Location:

Drawing Name:	Project No.
Date: 06/15/10	10-0165A
Type: LHSD-V3	
Drawn By: JDB	A-121
Scale: As Noted	Drawing No.




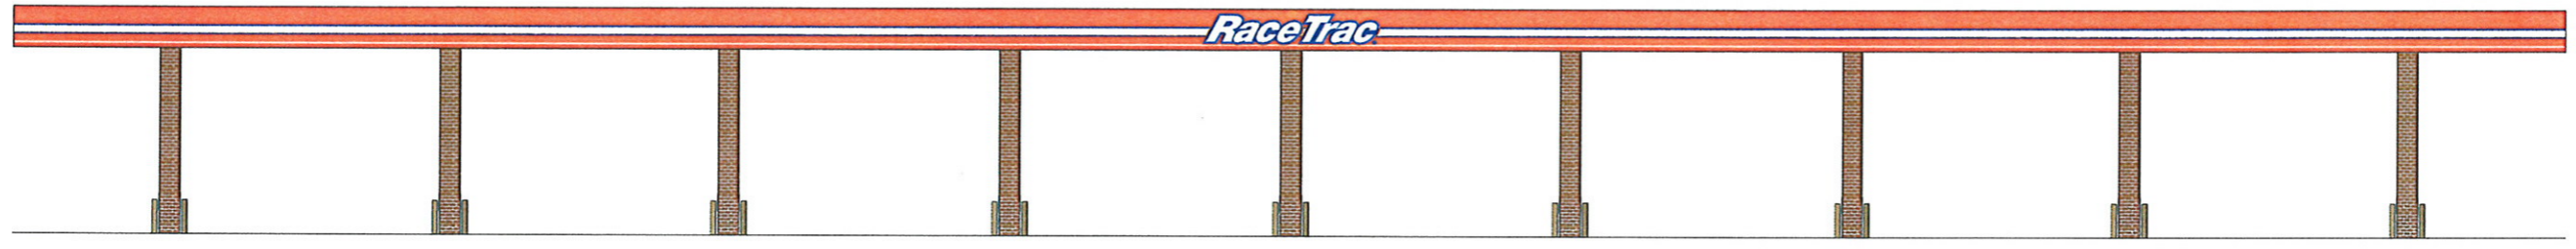

CANOPY FRONT ELEVATION

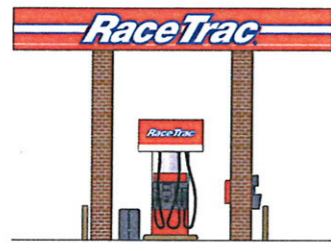

CANOPY SIDE ELEVATION

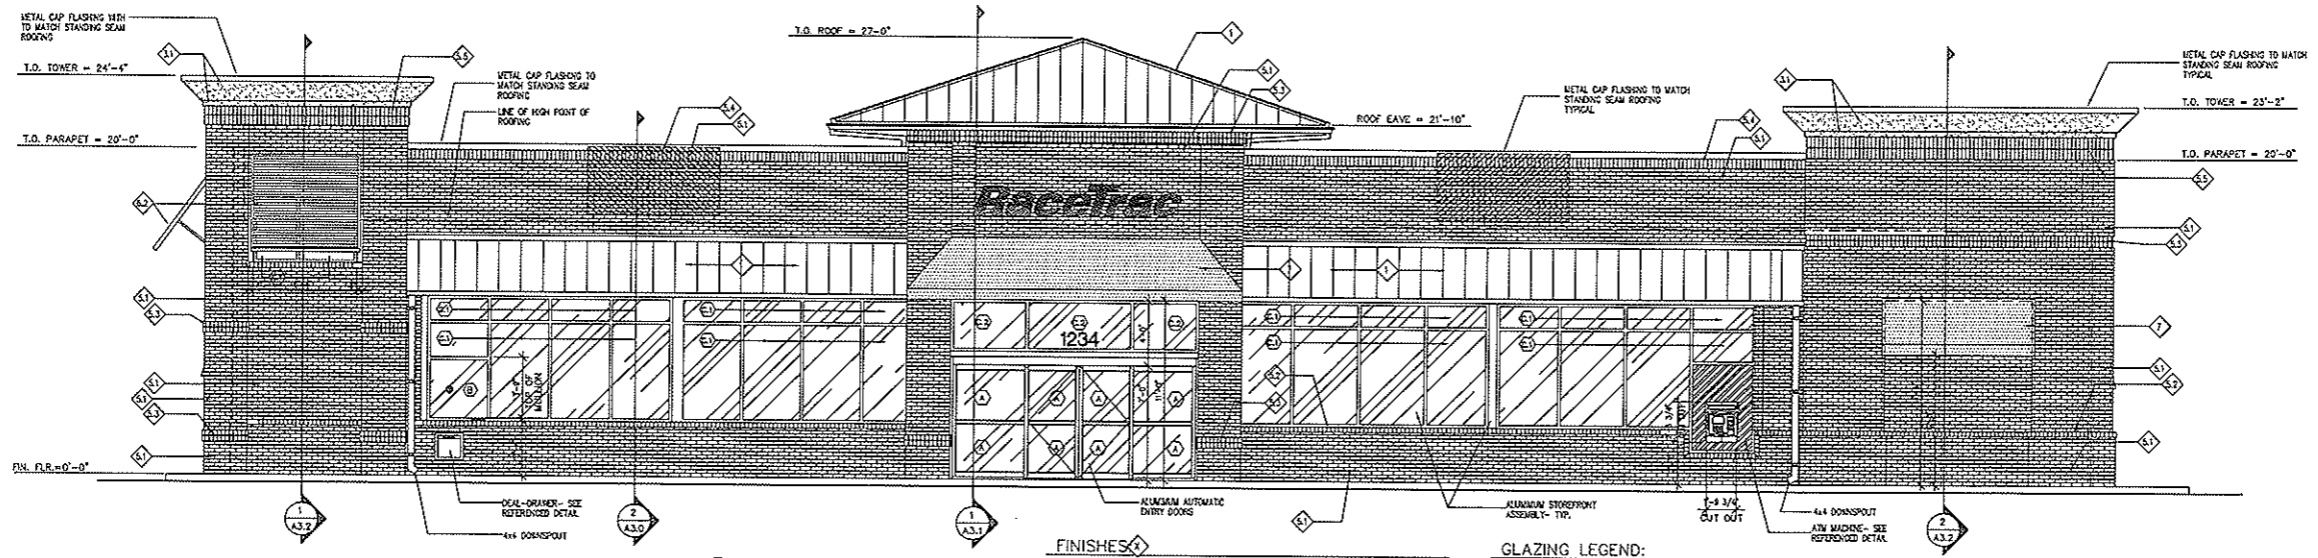

1 FRONT ELEVATION
A-2 SCALE: 3/16" = 1'-0"


FINISHES

1. STANDING SEAM METAL ROOFING
2. ALUMINUM STOREFRONT
- 2.1 PAINT COLOR #1
- 2.2 PAINT COLOR #2
- 2.3 PAINT COLOR #3
4. EXTERIOR WALL DOORS AND FRAMES
5. BRICK: MONTAR IS MANDOLIA BUFF BY LAFARGE:
 1. TRIPLE WALL BRICK
 2. BOW-LOCK SILL COURSE
 3. DE. BOW-LOCK ACCENT COURSE
 4. SOLID COURSE
 5. DR. SOLID COURSE
6. METAL ANVOS:
 1. 6'-0" WIDE x 7'-0" HIGH WALL MOUNTED
 2. 5'-0" WIDE x 5'-5" HIGH TOWER MOUNT
7. FABRIC ANVOS

GLAZING LEGEND:


- AUTOMATIC SLIDING DOORS BY HORTON AUTOMATICS, SERIES 200 LINEAR DRIVE DARK BRONZE ANODIZED FINISH, ARCHITECTURAL GLASS: 1" CLEAR DOUBLE-PANED TEMPERED GLASS.
- POLYCAST LEVEL 3
- STOREFRONT TO BE VSTAWALL ARCHITECTURAL PRODUCTS (PG 3000 SERIES, STOREFRONT FRAMING TO BE 1-3/4" X 4-1/2" DARK BRONZE ANODIZED FINISH, ARCHITECTURAL GLASS: 1" CLEAR DOUBLE-PANED TEMPERED GLASS.
- ARCHITECTURAL GLASS: 1" CLEAR DOUBLE-PANED TEMPERED GLASS.
- ARCHITECTURAL GLASS: 1" CLEAR DOUBLE-PANED TEMPERED GLASS.

NOTE: ALL GLASS TO HAVE V-KOOL 70 COATING

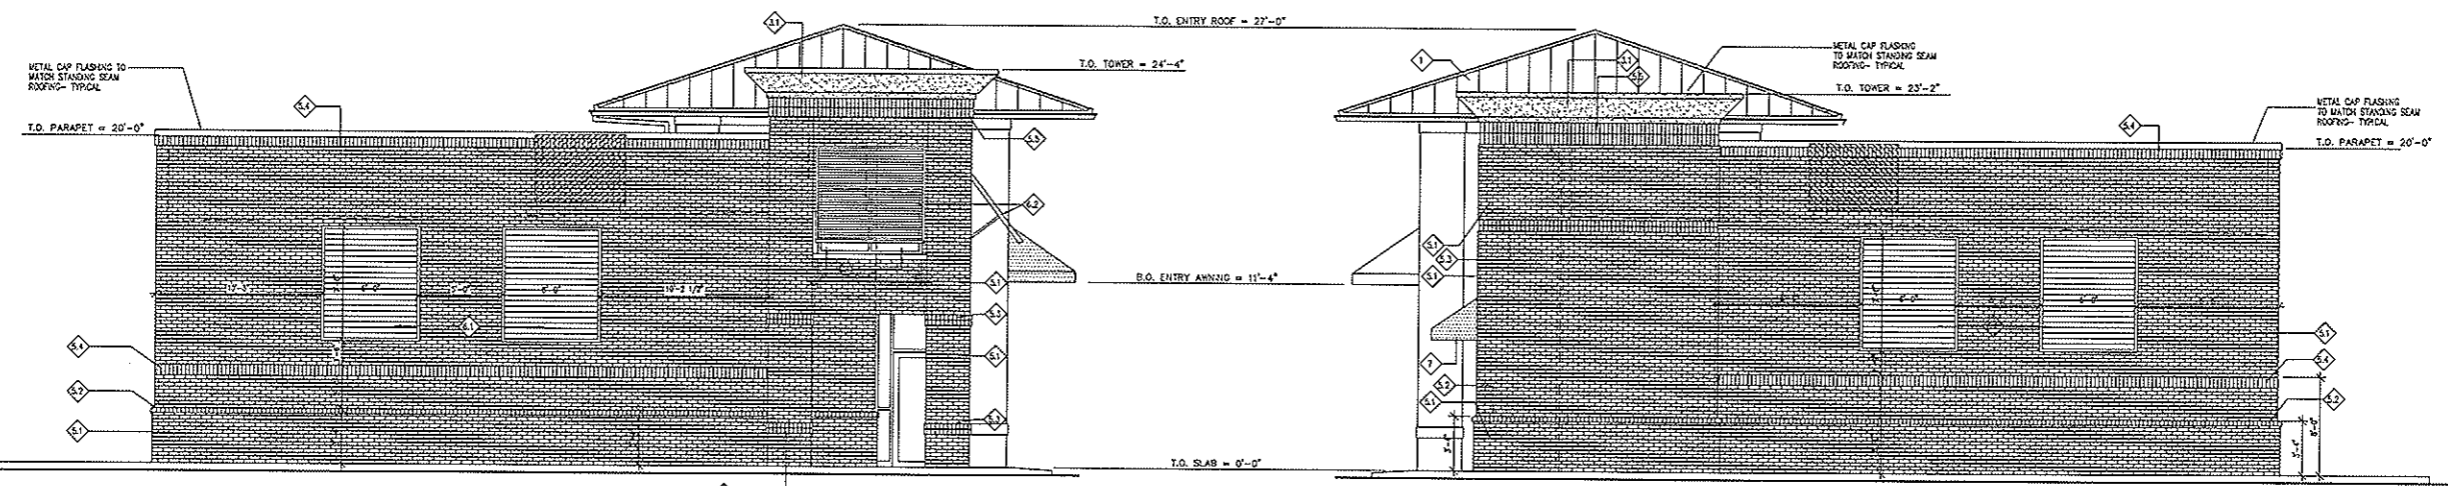

2 LEFT SIDE ELEVATION
A-2 SCALE: 3/16" = 1'-0"

3 RIGHT SIDE ELEVATION
A-2 SCALE: 3/16" = 1'-0"

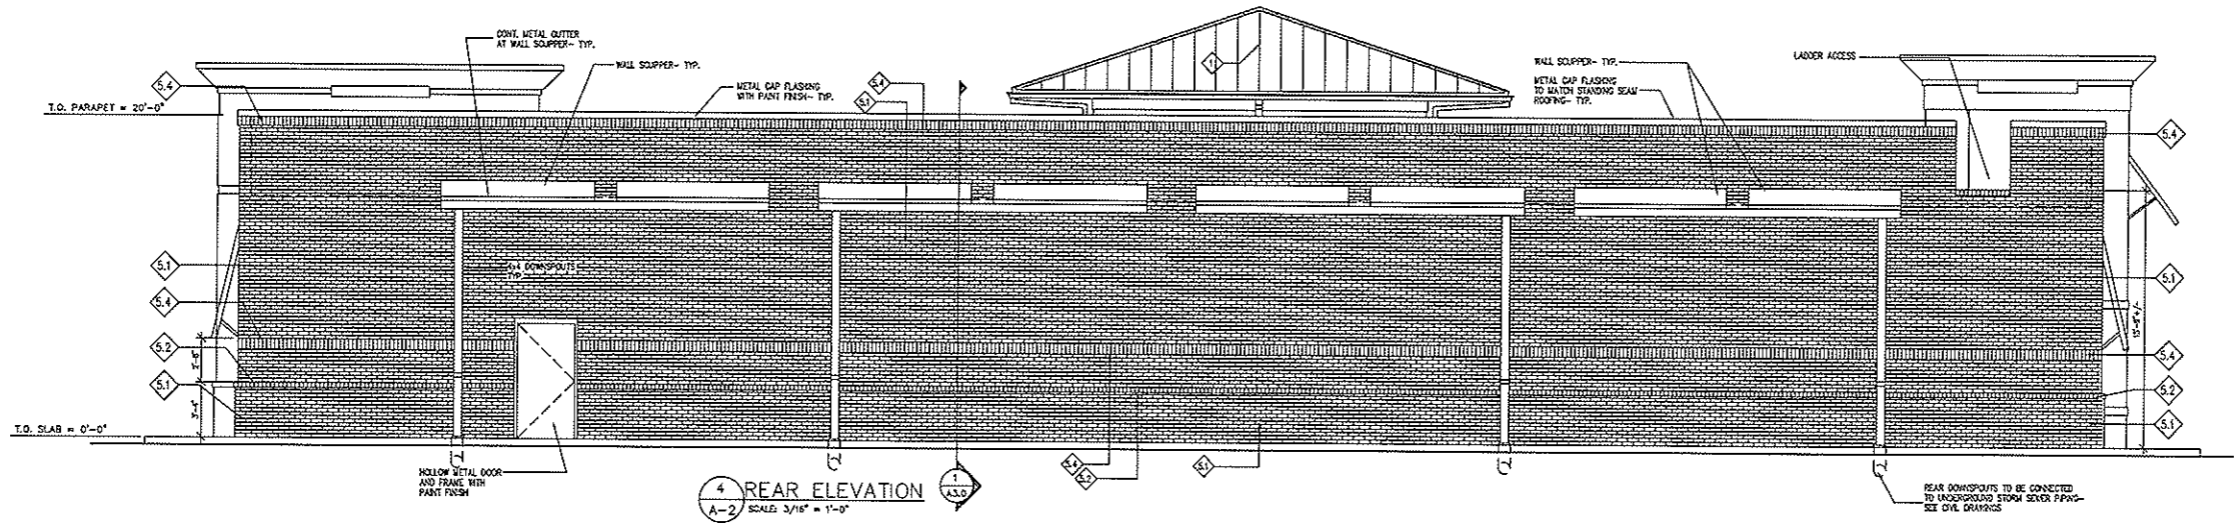

4 REAR ELEVATION
A-2 SCALE: 3/16" = 1'-0"

NO.	REVISIONS	BY	DATE

INTERPLAN
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EXTERIOR ELEVATIONS	RACETRAC SERVICE STATION - STORE #XX
SITE	STANDARD 5000TB
SCALE	3/16" = 1'-0"
DRAWN BY	JPDW
DATE	10/05/09
DRG NO.	

SHEET NO.	A2
REV.	