

All that tract or parcel of land lying in Land Lot 430 of the 1st District, 2nd
Section, Fulton County, Georgia and being more particularly described as
follows:

Beginning commencing at a 2-inch pipe found at the corner common to Land
Lots 408, 409, 429 and 430 and run thence North 01 Degrees 00 Minutes
19 Seconds West along the westerly line of Land Lot 430 North 01 Degrees
00 Minutes 19 Seconds West for a distance of 370.82 feet to a point; thence
North 00 Degrees 59 Minutes 27 Seconds West, for distance of 429.14 feet
to a point; thence North 00 Degrees 57 Minutes 24 Seconds West for a
distance of 105.27 feet to a point; thence leaving said westerly line of Land
Lot 430 North 77 Degrees 38 Minutes 45 Seconds East for a distance of
141.74 feet to a point; thence North 19 Degrees 06 Minutes 45 Seconds East
for a distance of 261.26 feet to a point on the southwestern Right-of-Way line
of Crossville Road (State Route 92); thence along the southwestern
Right-of-Way line of Crossville Road (State Route 92) South 52 Degrees 10
Minutes 17 Seconds East for a distance of 28.08 feet to a point; thence
continue along the southwestern Right-of-Way line of Crossville Road (State
Route 92) North 38 Degrees 25 Minutes 32 Seconds East for a distance of
24.10 feet to a point; thence continue along the southwestern Right of Way
line of Crossville Road (State Route 92) following the curvature there of to the
left on an arc length of 33.88 feet to a point, said curvature being subtended by
a chord bearing and distance of South 52 Degrees 03 Minutes 54 Seconds
East for a distance of 33.88 feet and having a radius of 1979.86 feet;
thence continue along the southwestern Right of Way line of Crossville Road
(State Route 92) South 09 Degrees 45 Minutes 59 Seconds East for a
distance of 46.26 feet to a point; thence continue along the southwestern Right
of Way line of Crossville Road (State Route 92) South 09 Degrees 45 Minutes
59 Seconds East for a distance of 27.05 feet to a point; thence continue along
the southwestern Right of Way line of Crossville Road (State Route 92) South
54 Degrees 45 Minutes 59 Seconds East for a distance of 40.00 feet to a point;
thence continue along the southwestern Right of Way line of Crossville Road
(State Route 92) North 80 Degrees 14 Minutes 01 Seconds East for a
distance of 26.10 feet to a point; thence continue along the southwestern Right
of Way line of Crossville Road (State Route 92) following the curvature there of
to the left on an arc length of 176.58 feet to a point, said curvature being
subtended by a chord bearing and distance of South 59 Degrees 15 Minutes
32 Seconds East, 176.52 feet and having a radius of 1979.86 feet; thence
leaving the southwestern Right of Way line of Crossville Road (State Route 92)
South 02 Degrees 59 Minutes 50 Seconds West, 986.25 feet to a point on the
southerly line of Land Lot 430; thence along said Land Lot line North 89
Degrees 48 Minutes 34 Seconds West, 198.17 feet to a point; thence South
89 Degrees 16 Minutes 38 Seconds West, 290.97 feet to The Point of
Beginning containing 12.45 Acres.

BRICKLEY SUBDIVISION
PLAT BOOK 144 PAGE 60
ZONING RI-PV

NOW OR FORMERLY
DORIS P. MASSEY
ZONING RI-PV

NOW OR FORMERLY
KODRA PROPERTIES, INC.
PARCEL 12-1980-0430-098-1
DB 33628 PG 503
ZONING RI-PV

NOW OR FORMERLY
UNITED STATES POSTAL SERVICE
PARCEL 12-1980-0430-099-9
DB 27905 PG 23
ZONING RI-PV

U.S.P.S.
1-STORY WAREHOUSE
PROCESSING FACILITY
#225 CROSSVILLE ROAD
ZONING RI-PV

NOW OR FORMERLY
JANE C. TOLBERT & NANCY TOLBERT
PARCEL 12-1980-0430-101-3
DB 45207 PG 0091
ZONING RI-PV

NOW OR FORMERLY
HACI YILMAZ & NANCY TOLBERT
PARCEL 12-1980-0430-101-3
DB 18192 PG 99
ZONING RI-PV


BLOCK "A"
BRANDON HEIGHTS SUBDIVISION
PLAT BOOK 136 PAGE 87
ZONING RI-PV

**TOTAL UNITED STATES
POSTAL SERVICE PROPERTY
542,221.20 S.F. = 12.45 ACRES**

TOTAL SITE AREA = 123,010.0 S.F. = 2.82 ACRES

PROP. S.F. OF IMPERVIOUS = 54,431 S.F. = 44%
PROP. S.F. OF PERVIOUS = 68,579.0 S.F. = 56%
PROP. S.F. OF BUILDING = 5020 S.F. = 4%
MAXIMUM LOT COVERAGE ALLOWED = 25% PROP. = 4%
PROP. S.F. OF LANDSCAPED AREA = 68,579 S.F. = 56%
PROP. % OF UNDEVELOPED/OPEN SPACE = 56%

VICINITY MAP

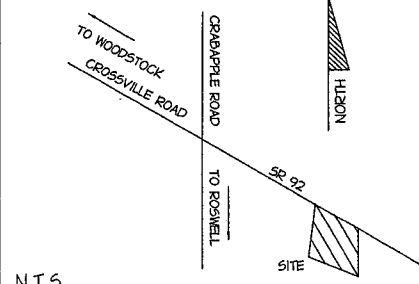

LEGEND

N.T.S.

RECEIVED
JUL 20 2009
City of Roswell
Community
Development
Dept.



THESE PLANS ARE SUBJECT
TO FEDERAL COPYRIGHT LAWS.
ANY USE OF SAME WITHOUT
THE EXPRESSED WRITTEN
PERMISSION OF RACETRAC
PETROLEUM INC. IS PROHIBITED.

TRACT 1 AREA
93,872.8 S.F. 2.155 ACRES
TRACT 2 AREA
29,137.2 S.F. 0.669 ACRES
TRACT 3 AREA
33,131.2 S.F. 0.761 ACRES
TOTAL TRACT 1 & 2 & 3
156,141.2 S.F. 3.585 ACRES
CURRENTLY ZONED
"RI-PV"
PROJECT AREA:
TRACT 1 & 2 = 2.82 ACRES
= 123,010 S.F.
TOTAL DISTURBED AREA = 2.82 ACRES

50 25 0 50 100 150
SCALE IN FEET

SITE PLAN
FOR
RACETRAC PETROLEUM, INC.

LOCATED
CROSSVILLE ROAD
LL 430 1ST DISTRICT 2ND SECTION
CITY OF ROSWELL
FULTON COUNTY, GEORGIA

SCALE 1"=50'
JOB NO: 5865 ZONING SUBMITTAL FIELD DATE 12/19/08
Harkleroad and Associates
Engineers - Land Surveyors
1808 Tree Lane ; Bldg. A ; Suite 101, Snellville, Ga. 30078
Phone (770) 982-1998 / Fax: (770) 982-1998

Racetrac
RACETRAC PETROLEUM INC.
3225 CUMBERLAND BOULEVARD
SUITE 100 ATLANTA, GA 30339
(770) 481-7800

P1	SITE PLAN	RACETRAC SERVICE STATION #890	
		CROSSVILLE ROAD ROSWELL, GEORGIA	
REV.	SCALE	1" = 50'-0"	DATE 06/10/09

NOW OR FORMERLY
UNITED STATES POSTAL SERVICE
PARCEL 12-1980-0430-099-9
DD 27905 PG 23
ZONING RI-PV

TBM = TOP OF CATCH
BASIN LID
EL=1087.11' (MSL)



PROPOSED
ADA H.C. RAMP

PROPOSED
ADA H.C. RAMP

SIDEWALK

#225 CROSSVILLE ROAD
BRICK WAREHOUSE
ZONING RI-PV

TOTAL SITE AREA = 123,010.0 S.F. = 2.82 ACRES

PROP. S.F. OF IMPERVIOUS = 54,431 S.F. = 44%
PROP. S.F. OF PERVIOUS = 68,579.0 S.F. = 56%
PROP. S.F. OF BUILDING = 5020 S.F. = 4%
MAXIMUM LOT COVERAGE ALLOWED = 25% PROP. = 4%
PROP. S.F. OF LANDSCAPED AREA = 68,579 S.F. = 56%
PROP. % OF UNDEVELOPED/OPEN SPACE = 56%

CITY OF ROSWELL FIRE NOTES:

CONTRACTOR SHALL CONTACT FIRE MARSHAL'S OFFICE FOR AN INSPECTION PRIOR TO PLACING BACK-FILL OVER NEWLY INSTALLED WATER FEED LINES. FAILURE TO CALL WILL RESULT IN REMOVING BACK-FILL FOR INSPECTIONS OF LINES, THROUST BLOCKS, ETC. (24 HOUR NOTICE IS REQUIRED) (770) 641-3750
HYDRANTS AND MAINS SHALL BE INSTALLED, TESTED, APPROVED AND UNDER PRESSURE BEFORE ANY COMBUSTIBLE CONSTRUCTION MATERIALS ARE DELIVERED TO THE SITE.


MAINTAIN ACCESS FOR EMERGENCY VEHICLES AROUND AND TO ALL BUILDINGS UNDER CONSTRUCTION. ACCESS SHALL BE A MINIMUM WIDTH OF TWENTY (20) FEET AND CAPABLE OF SUPPORTING FIRE TRUCKS AT TIMES OF RAIN OR M.D. PAVED OR HAVING A CRUSHED ROCK BASE, ETC. ROADWAYS SHALL BE CAPABLE OF SUPPORTING A GROSS WEIGHT OF 75,000 POUNDS.
FIRE HYDRANTS SHALL NOT BE BLOCKED FROM VIEW OR USE BY LANDSCAPING, OTHER UTILITIES, PARKED VEHICLES, STORAGE OR OTHER OBSTRUCTIONS.

A PRE-CONSTRUCTION MEETING WITH THE FIRE MARSHAL'S OFFICE REPRESENTATIVE SHALL BE CONDUCTED PRIOR TO THE BEGINNING OF CONSTRUCTION. A MINIMUM OF 24 HOURS NOTICE REQUIRED.

CITY OF ROSWELL PUBLIC WORKS NOTES:

ENSURE THAT TREE PLACEMENT WILL NOT INTERFERE WITH COMPOSTER COLLECTION.

NOTE: NO OVERHEAD DOORS
SINGLE STORY BUILDING
BUILDING HT. - 25' 0"
RACETRAC SERVICE STATION
GROSS BKG-5020 S.F.
AREA LIGHT FOOTCANDLES: 300 S.F.

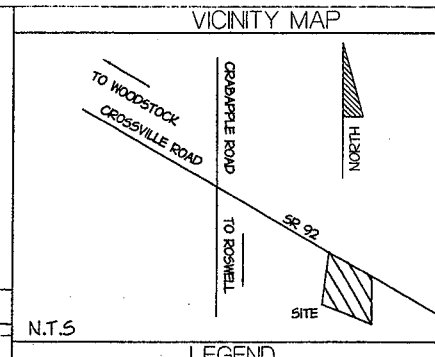

RECEIVED
JUL 20
CITY OF ROSWELL
COMMUNITY DEVELOPMENT DEPT.

GEORGIA
REGISTERED
PROFESSIONAL
LAND SURVEYOR
PATRICK HARKER

THESE PLANS ARE SUBJECT
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THE EXPRESSED WRITTEN
PERMISSION OF RACETRAC
PETROLEUM INC. IS PROHIBITED.

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CURRENTLY ZONED
"RI-PV"
PROJECT AREA:
TRACT 1 & 2 = 2.82 ACRES
= 123,010 S.F.
TOTAL DISTURBED AREA = 2.82 ACRES

SCALE IN FEET
0 20 40 60

SITE PLAN OF PROPOSED
DEVELOPED AREA
FOR
RACETRAC PETROLEUM, INC.
LOCATED
CROSSVILLE ROAD
LL 430 1ST DISTRICT 2ND SECTION
CITY OF ROSWELL
FULTON COUNTY, GEORGIA

SCALE 1" = 20'-0"
JOB NO. 5885CP
FIELD DATE 12/19/08

Harkleroad and Associates
Engineers - Land Surveyors
1608 Tree Lane - Bldg. A - Suite 101, Shalville, Ga. 30071
Phone (770) 582-1996 / Fax: (770) 582-1998

111	
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SPECIMEN TREE SURVEY DATA

Tree#	DBH	Species	Condition	Comments
258	28	Sweet Gum	Poor	Multiple broken scaffold limbs, co-dominant at approximately 25-feet, weak stem union, included bark
259	27	Sweet Gum	Poor	Large basal cavity, tree is hollow, approximate 10-degree lean from a vertical plane
260	28	Sweet Gum	Poor	Multiple broken scaffold limbs, co-dominant at approximately 20-feet, included bark, weak stem union
261	26	Sweet Gum	Good	
262	4	Dogwood	Dead	
263	28	Black Cherry	Poor	Large central leader broken out, basal wound with decayed wood at approximately 2-feet
264	4, 4, 4	Dogwood	Good	Tri-stem at approximately 3-feet
265	6, 4	Chinese Elm	Fair	Co-dominant at approximately 3-feet, multiple lower limbs slashed off by machete
266	8	Chinese Elm	Fair	Multi-stem at approximately 4-feet, multiple lower limbs slashed off by machete
267	31	Sweet Gum	Fair	Multiple broken scaffold limbs
268	34	Sweet Gum	Good	Few broken scaffold limbs


Summary

11 Total Trees Tagged
 3 trees are in Good condition
 3 trees are in Fair condition
 4 trees are in Poor condition
 1 tree is dead

Race Trac, Roswell Tree Survey by ArborGuard - 3/23/09, Page 2

EXISTING TREES TO REMAIN

NAME:	SIZE:	DU.
PINE	26"	6.9
PINE	26"	6.9
PINE	23"	6.3
PINE	21"	6
PINE	21"	6
PINE	20"	6
PINE	18"	5.7
PINE	18"	5.7
PINE	18"	5.7
PINE	18"	5.7
PINE	16"	5.3
PINE	16"	5.3
PINE	16"	5.3
PINE	16"	5.3
PINE	15"	4.8
PINE	15"	4.8
PINE	12"	4.2
PINE	12"	4.2
PINE	11"	3.6
PINE	11"	3.6
PINE	11"	3.6
PINE	10"	3.6
PINE	10"	3.6
PINE	9"	3
PIN OAK	8"	3
PIN OAK	8"	3
PIN OAK	7"	2.4
PIN OAK	7"	2.4
PIN OAK	6"	2.4
PIN OAK	6"	2.4
PIN OAK	5.5"	2
PIN OAK	5"	2
PIN OAK	5"	2
PIN OAK	5"	2
PIN OAK	4.5"	1.5
PIN OAK	4"	1.5
PIN OAK	3"	1
CHINESE ELM	8"	3
CHINESE ELM	8"	3
CHINESE ELM	6"	2.4
CHINESE ELM	6"	2.4
CHINESE ELM	6"	2.4
TOTAL:	497"	161.9

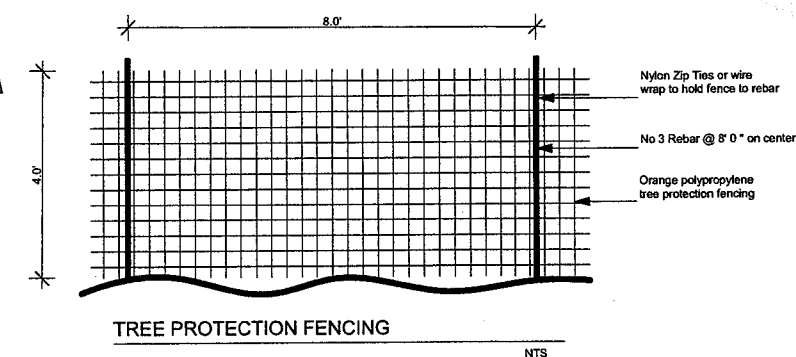

**manley
landdesign**

51 old canton street
 alpharetta, ga 30004
 770-442-8171
 770-442-1123 fax

RaceTrac
 RACETRAC PETROLEUM, INC.
 3225 CUMBERLAND BLVD.
 ATLANTA, GEORGIA 30339
 (770) 431-7600

**RaceTrac
Roswell**

Roswell, GA

date: 7/14/09
 scale: 1"= 30'-0"
 drawn by: ADN
 checked by: SLM
 job number: 2009015



issued



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sheet title

Tree Survey Plan

sheet number

L1.0
 1 of 2

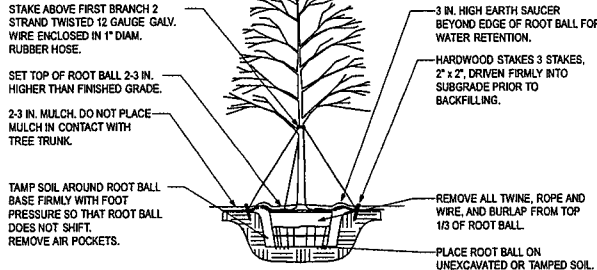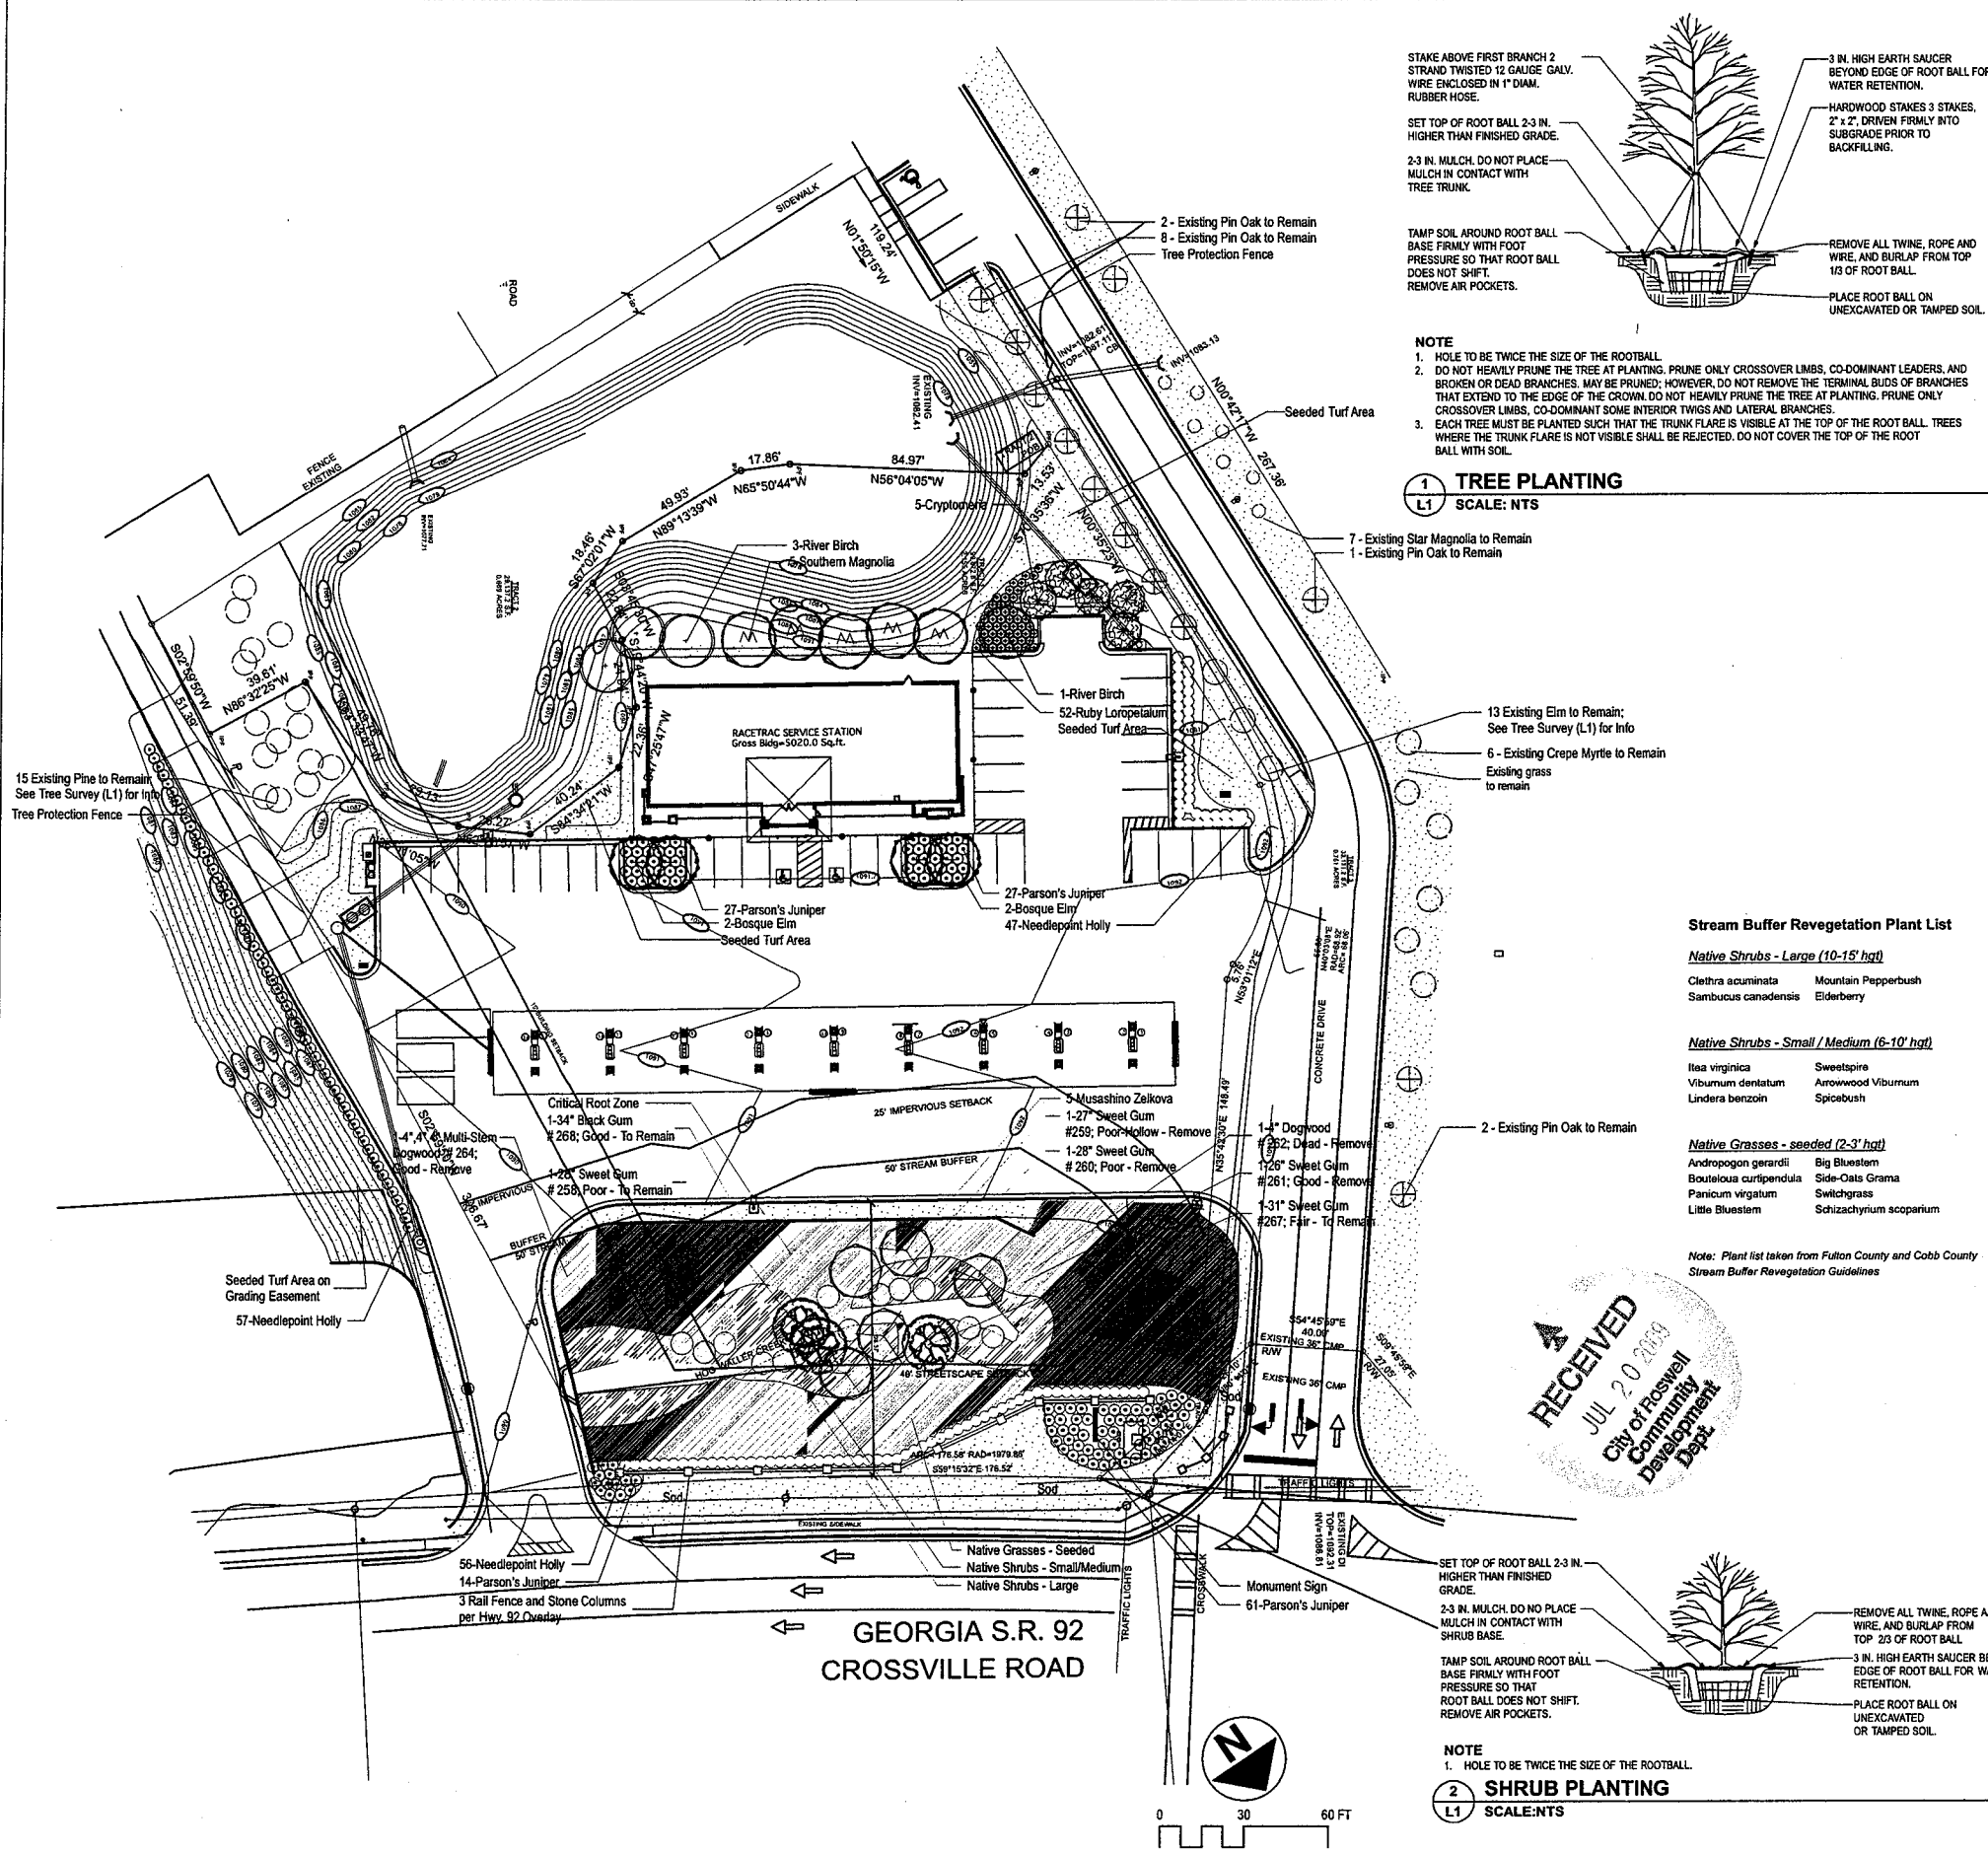


NOTE
1. HOLE TO BE TWICE THE SIZE OF THE ROOTBALL.
2. DO NOT HEAVILY PRUNE THE TREE AT PLANTING. PRUNE ONLY CROSSOVER LIMBS, CO-DOMINANT LEADERS, AND BROKEN OR DEAD BRANCHES. MAY BE PRUNED; HOWEVER, DO NOT REMOVE THE TERMINAL BUDS OF BRANCHES THAT EXTEND TO THE EDGE OF THE CROWN. DO NOT HEAVILY PRUNE THE TREE AT PLANTING. PRUNE ONLY CROSSOVER LIMBS, CO-DOMINANT SOME INTERIOR TWIGS AND LATERAL BRANCHES.
3. EACH TREE MUST BE PLANTED SUCH THAT THE TRUNK FLARE IS VISIBLE AT THE TOP OF THE ROOT BALL. TREES WHERE THE TRUNK FLARE IS NOT VISIBLE SHALL BE REJECTED. DO NOT COVER THE TOP OF THE ROOT BALL WITH SOIL.

1 TREE PLANTING
SCALE: NTS

Stream Buffer Vegetation Plant List

- Native Shrubs - Large (10-15' hgt)**
Clethra acuminata Mountain Pepperbush
Sambucus canadensis Elderberry
- Native Shrubs - Small / Medium (6-10' hgt)**
Itea virginica Sweetgum
Viburnum dentatum Arrowwood Viburnum
Lindera benzoin Spicebush
- Native Grasses - seeded (2-3' hgt)**
Andropogon gerardii Big Bluestem
Bouteloua curtipendula Side-Oats Grama
Panicum virgatum Switchgrass
Little Bluestem Schizachyrium scoparium

Note: Plant list taken from Fulton County and Cobb County Stream Buffer Vegetation Guidelines

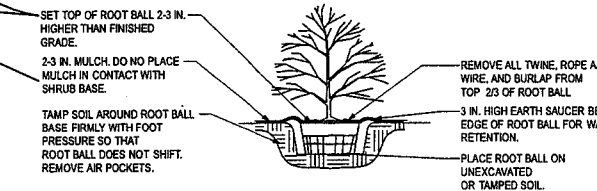

NOTE
1. HOLE TO BE TWICE THE SIZE OF THE ROOTBALL.
2. SET TOP OF ROOT BALL 2-3 IN. HIGHER THAN FINISHED GRADE.
3. 3 IN. MULCH, DO NOT PLACE MULCH IN CONTACT WITH TREE TRUNK.
4. TAMP SOIL AROUND ROOT BALL BASE FIRMLY WITH FOOT PRESSURE SO THAT ROOT BALL DOES NOT SHIFT. REMOVE AIR POCKETS.

2 SHRUB PLANTING
SCALE: NTS

LANDSCAPE REQUIREMENTS

A. SITE DENSITY REQUIRED

Site: 3.585 Acres
30 x 3.6 = 108.0 Density Units Required (SDF)
SDF = EDF + RDF

PROVIDED	1. EDF:	15 Pines	81.9
		13 Pin Oak	27.6
		3 Elm	7.2
		2 Sweet Gum	14.8
		1 Black Gum	8.1
		Total EDF	139.6

2. RDF:

4 Bosque Elm	4" CAL	x 0.9 =	3.6
5 Cryptomeria	4" CAL	x 0.9 =	4.5
4 River Birch	4" CAL	x 0.9 =	3.6
5 Magnolia	4" CAL	x 0.9 =	4.5
5 Zelkova	4" CAL	x 0.9 =	4.5
		Total RDF	20.7

139.6 + 20.7 = 160.3 SDF

B. INTERIOR PARKING LOT LANDSCAPING

REQUIRED

- Not less than ten percent of the interior of a parking lot shall be landscaped.
- Interior parking lot landscaping islands shall be required; Min. 400 SF.
- At least 2 overstory trees in each interior parking lot landscaping island.

PROVIDED

- Min. 400 SF per island
- 2 Bosque Elm per landscape island

C. LANDSCAPE STRIP ADJACENT TO STREET R.O.W.

REQUIRED

- 1 Shade Tree & 10 Shrubs per 35 LF of street frontage
GA. SR. 92 = 275 LF
275 LF / 35 = 7.85
Overstory Trees Required: 8
Shrubs Required: 80
70 Percent of the shrubs shall be evergreen
80 Shrubs Req. x 70 percent = 56 Req. Evergreen Shrubs
- Shrubs shall be 2-6' Hgt.; Min. at planting

PROVIDED

- 2 Existing Sweet Gum
1 Existing Black Gum
5 Zelkova
57 Needlepoint Holly
23 Arrowwood Viburnum
- 70% + are Evergreen

D. SPECIMEN RECOMPENSE

	Size:	Name:	Condition:	DU
TO BE REMOVED	1. 4", 4", 4" DBH	Dogwood	Good	@ 1.5 = 4.5
	26" DBH	Sweet Gum	Good	@ 6.9 = 6.9
				11.4 Recompense
PROVIDED	1. 5 Magnolia	4" CAL	x 0.9 =	4.5
	2. 3 River Birch	4" CAL	x 0.9 =	2.7
	3. 5 Cryptomeria	4" CAL	x 0.9 =	4.5
				Total Recompense = 11.7 DU

PLANT LIST

Qty	Botanical Name	Common Name	Scheduled Size	Remarks
Trees				
4	Betula nigra	River Birch	4" Cal.	
5	Cryptomeria japonica	Cryptomeria	4" Cal.	
5	Magnolia grandiflora	Southern Magnolia	4" Cal.	Full to ground
4	Ulmus parvifolia 'Bosque'	Bosque Elm	4" Cal.	Straight Leader
5	Zelkova serrata 'Musashino'	Musashino Zelkova	4" Cal.	Straight Leader; B & B
Shrubs				
160	Ilex cornuta 'Needlepoint'	Needlepoint Holly	3 Gal.	Maintained at 3' - 4' Hgt.
129	Juniperus davurica 'Parsonii'	Parson's Juniper	3 Gal.	Maintained at 2' - 3' Hgt.
52	Loropetalum chinensis 'Ruby'	Ruby Loropetalum	3 Gal.	Maintained at 3' - 4' Hgt.
Groundcovers				
6740	Cynodon dactylon	Hybrid Bermuda Grass	SF; Sod	

LANDSCAPE NOTES

- Contractor responsible for locating and protecting all underground utilities prior to digging.
- Contractor responsible for protecting existing trees from damage during construction.
- Do not install weed barrier fabric in groundcover beds.
- Install 4 inches minimum depth of topsoil at planting beds and lawn areas, 12 inches minimum below trees. In locations with high clay content, apply gypsum additives to break down the clay.
- All shrubs beds (existing and new) to be mulched with a 2 inch minimum layer of shredded bark mulch.
- All annual and perennial beds to be filled to a minimum depth of 18 inches and amended with 4 inches of organic material. Mulch planted annual and perennial beds with 4 inch depth of mini nuggets.
- Planting holes to be dug a minimum of twice the width and 6 inches deeper than the size of the root ball of both shrub and tree and to be amended with organic soil conditioner (ie. Nature's Helper or Pro Mix). Backfill and tamp bottom of hole prior to planting so top of root ball does not settle below surrounding grade.
- Existing grass in proposed planting areas to be killed and removed and area to be hand raked to remove all rocks and debris larger than 1 inch in diameter prior to planting shrubs.
- Any existing grass disturbed during construction to be fully removed, regraded and replaced. All fire marks and indentations to be repaired.
- Soil to be tested to determine fertilizer and lime requirements and distributed prior to laying sod.
- Sod to be delivered fresh (Cut less than 24 hours prior to arriving on site), laid immediately, rolled, and watered thoroughly immediately after planting. Edge of sod is to be trenched.
- All changes to design or plant substitutions are to be authorized by the Landscape Architect.
- Planting Mix to be 4 parts screened topsoil and 1 part organic material (ie. Nature's Helper or Pro Mix).
- All landscaping shall be installed in conformance with ANSI Z60.1 the "American Standard for Nursery Stock" and the accepted standards of the American Association of Nurserymen.
- The Landscape Contractor shall guarantee all plants installed for one full year from date of acceptance by the owner. All plants shall be alive and at a vigorous rate of growth at the end of the guarantee period. The Landscape Contractor shall not be responsible for acts of God or vandalism.
- Any plant that is determined dead, in an unhealthy or unlight condition, lost its shape due to dead branches or other symptoms of poor, non-vigorous growth shall be replaced by the Landscape Contractor with the cost of the replacement included in the bid or proposal price.
- Prior to installation, the Landscape Contractor shall inspect the subgrade, general site conditions, verify elevations, utility locations, irrigation, approve topsoil provided by General Contractor and observe the site conditions under which the work is to be done. Notify General Contractor of any unsatisfactory conditions, and work shall not proceed until such conditions have been corrected and are acceptable to the Landscape Contractor.
- Stake all evergreen and deciduous trees.
- Water thoroughly twice in first 24 hours and apply mulch immediately.
- The plant quantities are for the contractor's convenience. All numbers must be verified.
- Site to be 100% irrigated in all planting beds and grass area by an automatic underground irrigation system.
- All tree protection areas to be protected from sedimentation.
- All tree protection devices to be installed prior to the start of land disturbance, and maintained until final landscaping.
- All tree protection fencing to be inspected daily, and repaired or replaced as needed.
- No parking, storage or other construction activities are to occur within tree protection areas.

manley landdesign
51 old canton street
alpharetta, ga 30004
770-442-8171
770-442-1123 fax

Racetrac
RACETRAC PETROLEUM, INC.
3325 CUMBERLAND BLVD.
ATLANTA, GEORGIA 30339
(770) 431-7600

RaceTrac Roswell
Roswell, GA

date: 7/20/09
scale: 1"=30'-0"
drawn by: C/JG
checked by: SLM
job number: 2009015




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sheet title
Landscape Plan

sheet number
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VICINITY MAP

LEGEND

ICV	IRIGATION CONTROL VALVE
IPF	IRON PIN FOUND
IPS	IRON PIN SET (1/2" RB)
OT	OPEN TOP PIPE
CT	CRIMP TOP PIPE
QMF	CONCRETE MONUMENT FOUND
N & C	NAIL AND CAP
RP	REBAR
PP	POWER POLE
TP	TELEPHONE POLE
LL	LAND LOT LINE
LL	POINT OF BEGINNING
BL	BUILDING LINE
CL	CENTER LINE
PL	PROPERTY LINE
PH	PIPE HYDRANT
CB	CATCH BASIN
DI	DROP INLET
HW	HEAD WALL
JB	JUNCTION BOX
DE	DRAINAGE EASEMENT
WM	WATER METER
WV	WATER VALVE
GV	GAS VALVE
MT	MAN HOLE
UT	TELEPHONE LINE
UT	BURIED TELEPHONE CABLE
G	GAS LINE (APPROXIMATE LOCATION)
W	WATER LINE (APPROXIMATE LOCATION)
S/S	SANITARY SEWER LINE
SD	STORM DRAIN LINE
SB	RIGHT OF WAY MONUMENT FOUND
X	ANCHOR
-	POWER LINE (OVERHEAD)
-	FENCE
-	FIRE HYDRANT

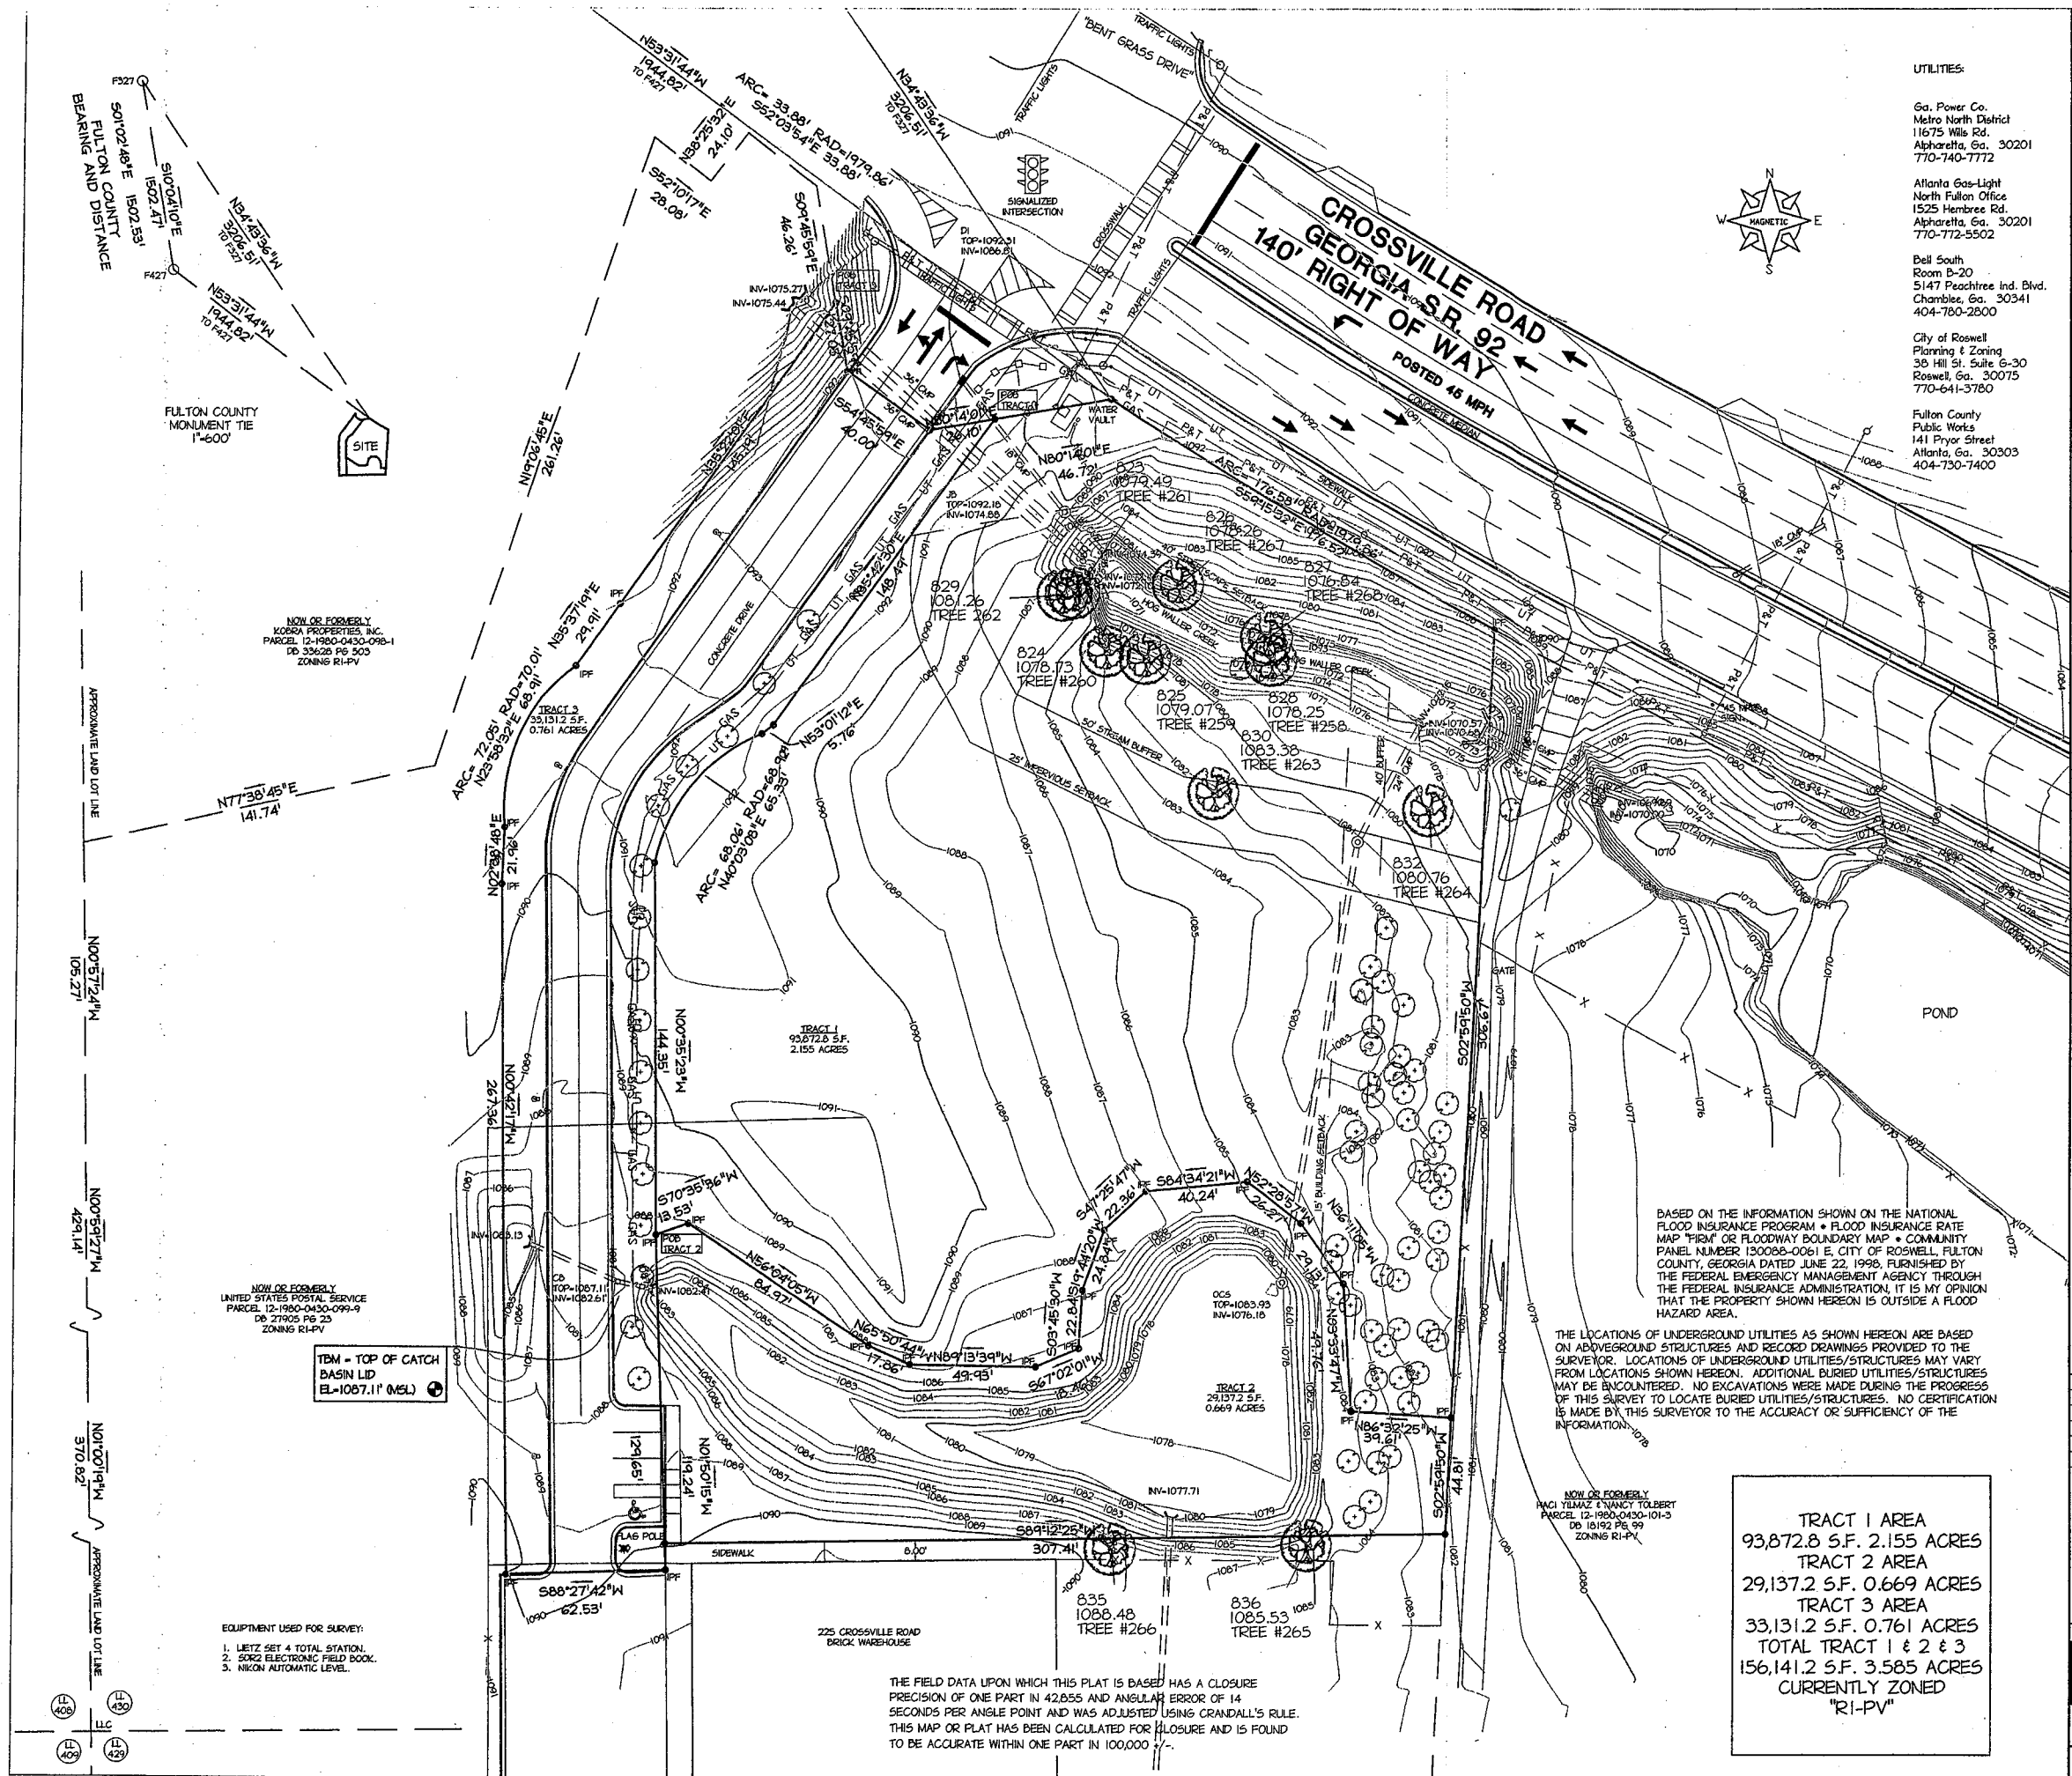RECEIVED
JUL 20 2009
City of Roswell
Community Development Dept.

THIS IS TO CERTIFY THAT THIS MAP OR PLAN AND THE SURVEY ON WHICH IT IS BASED WERE MADE IN ACCORDANCE WITH THE MINIMUM STANDARD DETAIL REQUIREMENTS FOR ALTA/ACSM LAND TITLE SURVEYS, JOINTLY ESTABLISHED AND ADOPTED BY ALTA AND NSPS IN 2005, AND INCLUDES ITEMS 1 THRU 4, 6 THRU 11, 13 AND 14 OF TABLE A HEREON. PURSUANT TO THE ACCURACY STANDARDS AS ADOPTED BY ALTA AND NSPS AND IN EFFECT ON THE DATE OF THIS CERTIFICATION, UNDERSIGNED FURTHER CERTIFIES THAT IN MY PROFESSIONAL OPINION, AS A LAND SURVEYOR REGISTERED IN THE STATE OF GEORGIA, THE RELATIVE POSITIONAL ACCURACY OF THIS SURVEY DOES NOT EXCEED THAT WHICH IS SPECIFIED HEREON.

DATE: _____

By: _____

SCALE IN FEET

ALTA/ACSM LAND TITLE SURVEY
FOR
DEL LAGO VENTURES, INC.
RACETRAC PETROLEUM, INC.
ANDALUSIA PROPERTIES, INC.
FIRST AMERICAN TITLE INSURANCE COMPANY
METROPOLITAN TITLE AGENCY, INC.

LOCATED
CROSSVILLE ROAD
LL 430 1ST DISTRICT 2ND SECTION
CITY OF ROSWELL
FULTON COUNTY, GEORGIA

SCALE: 1" = 30'-0" JOB NO.: 5685SRVY FIELD DATE: 12/19/08

Harkleroad and Associates
Engineers - Land Surveyors
1608 Tree Lane ; Bldg. A ; Suite 101, Snellville, Ga. 30078
Phone (770) 982-1996 / Fax: (770) 982-1998

TRACT 1 AREA
93,872.8 S.F. 2.155 ACRES
TRACT 2 AREA
29,137.2 S.F. 0.669 ACRES
TRACT 3 AREA
33,131.2 S.F. 0.761 ACRES
TOTAL TRACT 1 & 2 & 3
156,141.2 S.F. 3.585 ACRES
CURRENTLY ZONED
"RI-PV"

THE FIELD DATA UPON WHICH THIS PLAT IS BASED HAS A CLOSURE PRECISION OF ONE PART IN 42,655 AND ANGULAR ERROR OF 14 SECONDS PER ANGLE POINT AND WAS ADJUSTED USING CRANDALL'S RULE. THIS MAP OR PLAT HAS BEEN CALCULATED FOR CLOSURE AND IS FOUND TO BE ACCURATE WITHIN ONE PART IN 100,000.

EQUIPMENT USED FOR SURVEY:
1. LEITZ SET 4 TOTAL STATION.
2. SOKK ELECTRONIC FIELD BOOK.
3. NIKON AUTOMATIC LEVEL.

REVISIONS

NO.	REVISION	DATE
1	REVISED BOUNDARY AND SITE DESCRIPTIONS	3/18/09

RECEIVED
JUL 20 2009
City of Roswell
Community Development Dept.

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Racetrac
RACETRAC PETROLEUM, INC.
3225 CUMBERLAND BOULEVARD
SUITE 100 ATLANTA, GA 30339
(770) 431-7600

ALTA/ACSM SURVEY
RACETRAC SERVICE STATION #890
CROSSVILLE ROAD
ROSWELL, GEORGIA
DATE 12/19/08
SCALE 1" = 30'-0" DRAWN TELJR

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SHEET 1 OF 2